

DOST NORTH GATE SIGNAGE



DOST TOWER SIGNAGE



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REPUBLIC OF THE PHILIPPINES DEPARTMENT OF PUBLIC WORKS AND HIGHWAYS

OFFICE OF THE BUILDING

OFFICIAL TAGUIG CITY

LAND USE AND ZONING

LINE AND GRADE

ARCHITECTURAL

STRUCTURAL

SANITARY

ELECTRICAL

MECHANICAL

DOST GROUND SIGNAGE







MIRDC COVERED WALKWAY



COVERED MOTORCYCLE PARKING

THIS SITE



SPEED LIMIT SIGN 1




SPEED LIMIT SIGN 2



SLOW DOWN SIGN 1



SLOW DOWN SIGN 2

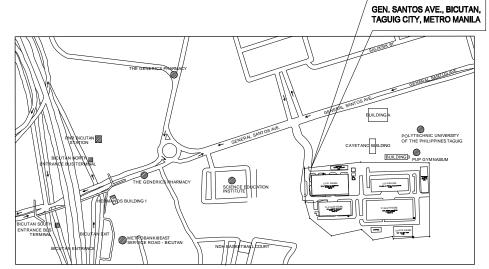

VICINITY MAP







PERSPECTIVES



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CIVIL/STRUC	CTURAL ENGINEE	R:	PROJECT TITLE :	OWNER:	DATE:	REVISION:	DESCRIPTION:	DESIGNED BY:		SHEET CONTENTS:	DRAWING NO. :
			DDODOCED COVEDED WALKWAY DADKING	METAL INDUSTRY RESEARCH AND				CADD BY:	RHV		Λ 1
_	PROPOSED COVERED WALKWAY, PARKING AND DOST NORTH GATE SIGNAGE		DEVELOPMENT CENTER (MIRDC)				DATE:		PERSPECTIVES	A - 1	
REG. NO.:	055251	PTR NO.: 2321899						CHECKED BY:	GBM	VICINITY MAP TABLE OF CONTENTS	SHEET NO.:
DATE:	AUG. 1, 1989	ISSUED ON: JAN. 4, 2017	LOCATION:	ADDRESS:				APPROVED BY:			1 / 22
TIN:	106-459-911	ISSUED AT: PASIG CITY	GEN. SANTOS AVE., BICUTAN, TAGUIG CITY, METRO MANILA	GEN. SANTOS AVE., BICUTAN, TAGUIG CITY, METRO MANILA				DATE:			1 / 22



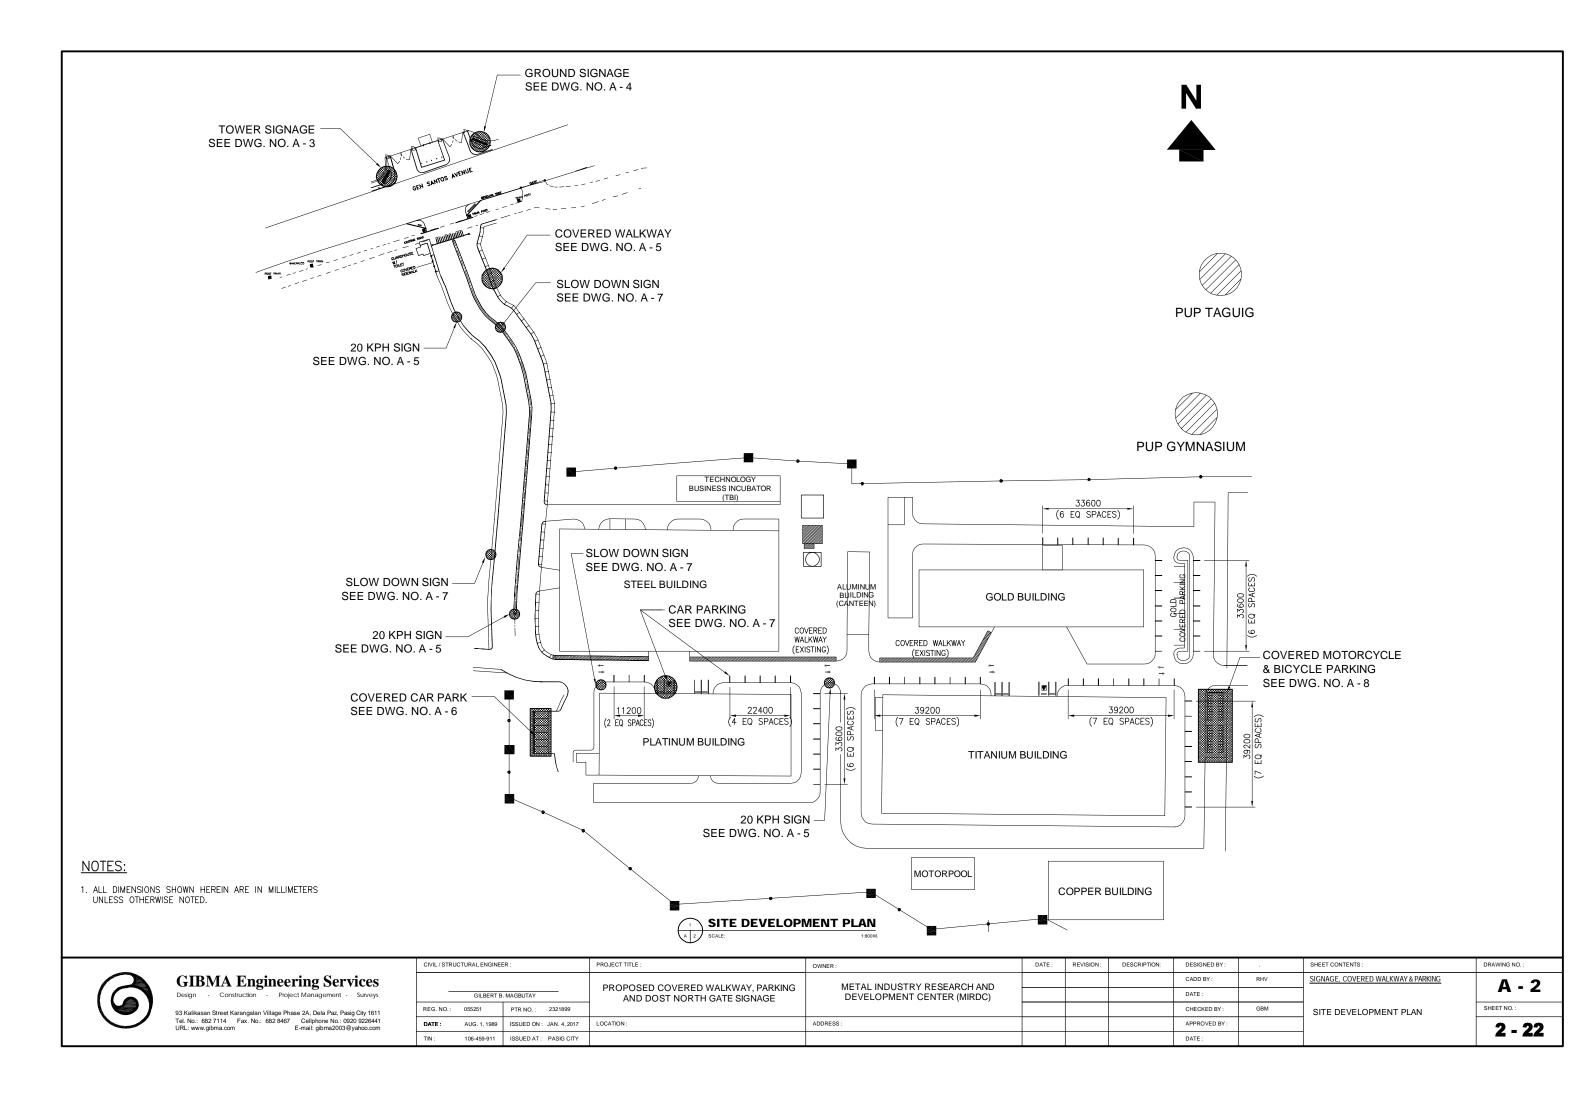

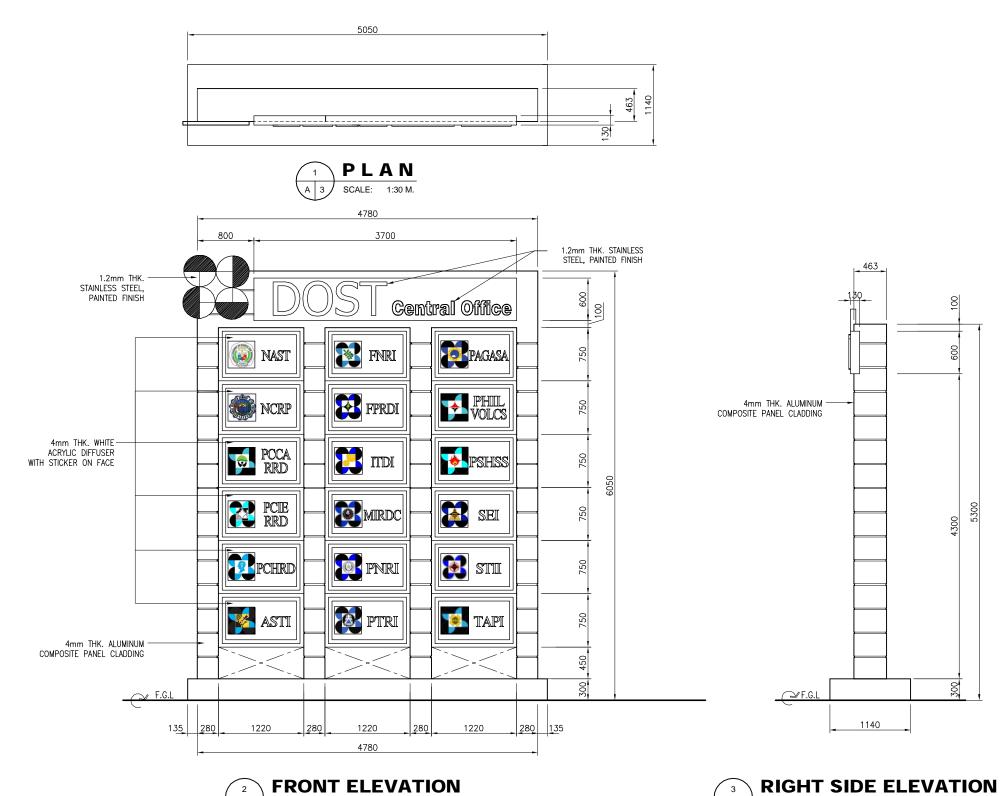- 1. ALL DIMENSIONS SHOWN HEREIN ARE IN MILLIMETERS UNLESS OTHERWISE NOTED.
- 2. FOR SITE DEVELOPMENT PLAN, REFER TO DRAWING NO. A-2.
- 3. VERIFY ALL SIZES/DIMENSIONS ON THE JOB SITE AND SUBMIT SHOP DRAWINGS PRIOR TO FABRICATION AND INSTALLATION.
- 4. ALL SHOP DRAWINGS, SAMPLES CATALOG CUTS, ETC. ARE TO BE APPROVED BY THE ARCHITECT BEFORE THE FINAL EXECUTION.

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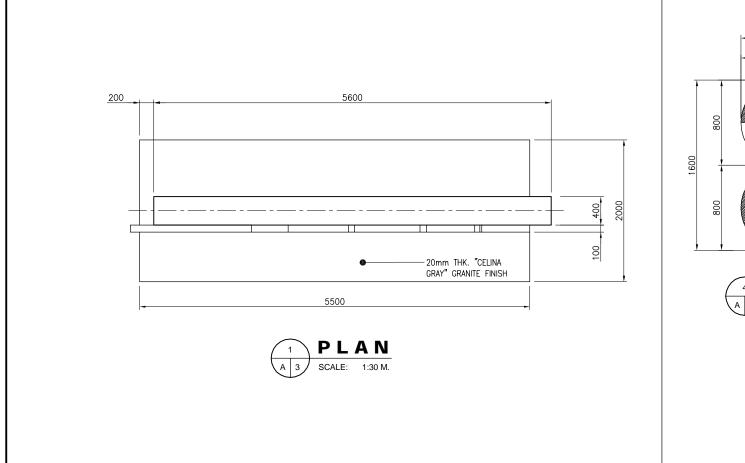
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Tel. No.: 682 7114 Fax. No.: 682 8467 Cellphone No.: 0920 9226441
URL: www.gibma.com E-mail: gibma2003@yahoo.com


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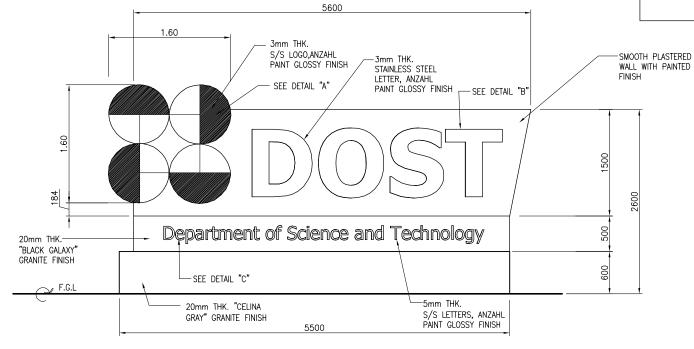
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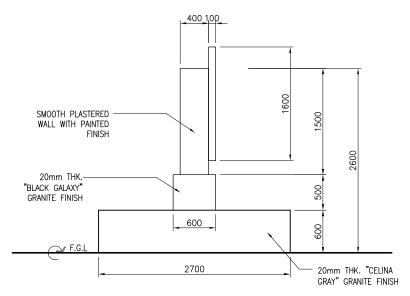
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CIVIL / STR	RUCTURAL ENGINE	ER:	PROJECT TITLE :	OWNER:	DATE:	REVISION:	DESCRIPTION:	DESIGNED BY:		SHEET CONTENTS:	DRAWING NO.:
GILBERT B. MAGBUTAY			PROPOSED COVERED WALKWAY, PARKING	METAL INDUSTRY RESEARCH AND DEVELOPMENT CENTER (MIRDC)				CADD BY:	RHV	TOWER SIGNAGE	Λ 2
		B. MAGBUTAY	AND DOST NORTH GATE SIGNAGE					DATE:		PLAN	A - 3
REG. NO.:	055251	PTR NO.: 2321899						CHECKED BY:	GBM	FRONT ELEVATION	SHEET NO.:
DATE:	AUG. 1, 1989	ISSUED ON: JAN. 4, 2017	LOCATION:	ADDRESS:				APPROVED BY:		RIGHT SIDE ELEVATION	3 / 22
TIN:	106-459-911	ISSUED AT: PASIG CITY	GEN. SANTOS AVE., BICUTAN, TAGUIG CITY, METRO MANILA	GEN. SANTOS AVE., BICUTAN, TAGUIG CITY, METRO MANILA				DATE:			J / ZZ







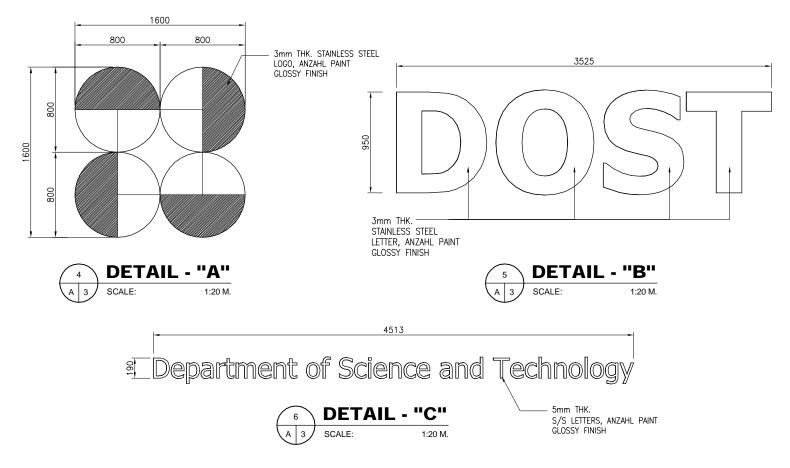

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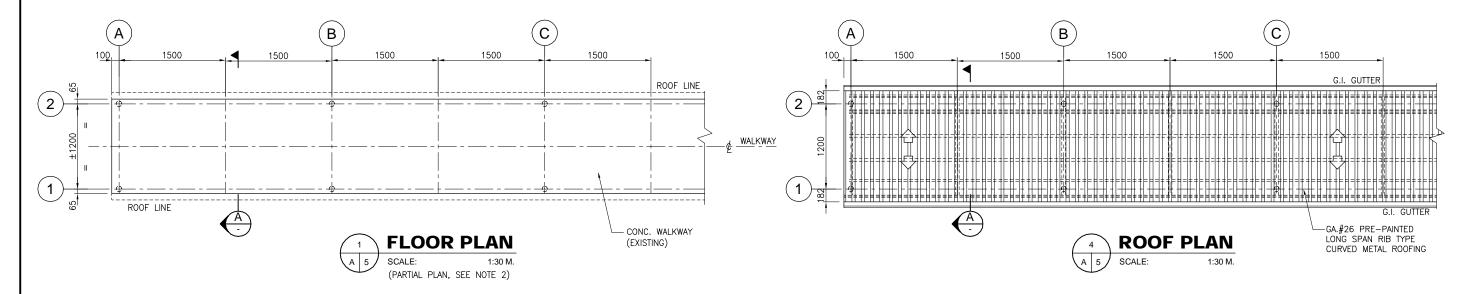





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			DDODOCED COVEDED MALKIMAY DADKING	METAL INDUSTRY RESEARCH AND				CADD BY:	RHV	GROUND SIGNAGE	Λ_Λ
GILBERT B. MAGBUTAY		s. MAGBUTAY	PROPOSED COVERED WALKWAY, PARKING AND DOST NORTH GATE SIGNAGE	DEVELOPMENT CENTER (MIRDC)				DATE:		PLAN & DETAILS	A - 4
REG. NO.:	055251	PTR NO.: 2321899						CHECKED BY:	GBM	FRONT ELEVATION	SHEET NO.:
DATE:	AUG. 1, 1989	ISSUED ON: JAN. 4, 2017	LOCATION:	ADDRESS:				APPROVED BY :		LEFT SIDE ELEVATION	4 / 22
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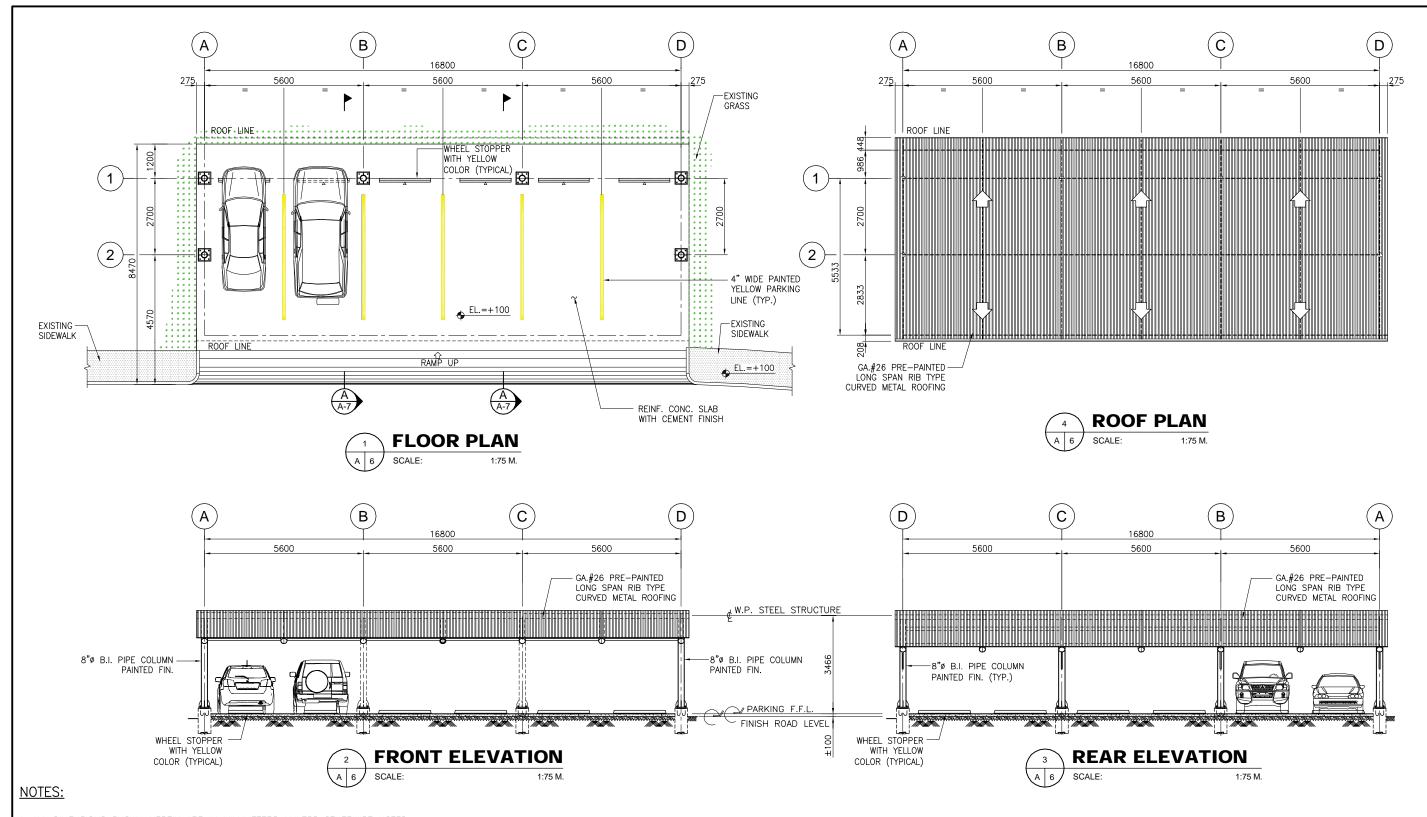




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CIVIL / STRUCTURAL ENGIN	NEER:	PROJECT TITLE :	OWNER:	DATE:	REVISION:	DESCRIPTION:	DESIGNED BY:		SHEET CONTENTS:	DRAWING NO.:
GILBERT B. MAGBUTAY		PROPOSED COVERED WALKWAY, PARKING	METAL INDUSTRY RESEARCH AND DEVELOPMENT CENTER (MIRDC)				CADD BY:	RHV	COVERED WALKWAY	Λ - 5
		AND DOST NORTH GATE SIGNAGE					DATE:			A-3
REG. NO.: 055251	PTR NO.: 2321899						CHECKED BY:	GBM	FLOOR & ROOF PLAN FRONT ELEVATION	SHEET NO.:
DATE: AUG. 1, 1989	9 ISSUED ON: JAN. 4, 2017	LOCATION:	ADDRESS:				APPROVED BY:		SECTION "A"	5 - 22
) 3 - 22

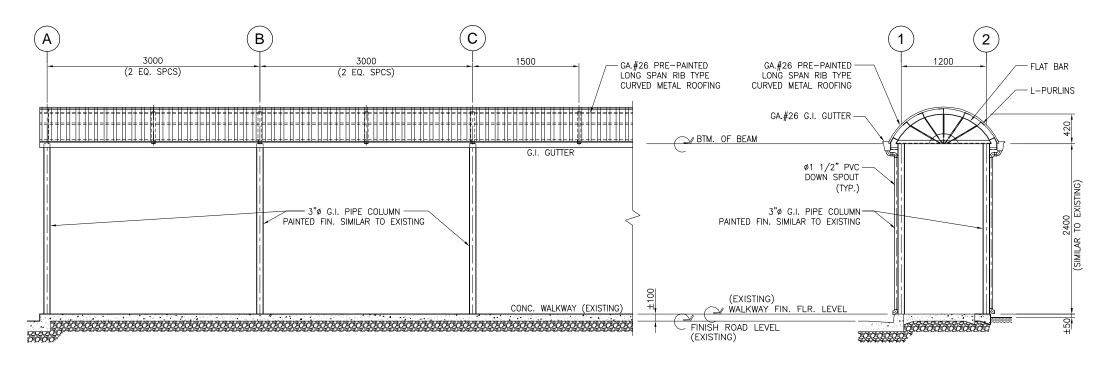

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Г				PROPOSED COVERED WALKWAY, PARKING	METAL INDUSTRY RESEARCH AND				CADD BY:	RHV	COVERED CAR PARK
	GILBERT B. MAGBUTAY		. MAGBUTAY	AND DOST NORTH GATE SIGNAGE	DEVELOPMENT CENTER (MIRDC)				DATE:		FLOOR P L A N
	REG. NO.:	055251	PTR NO.: 2321899						CHECKED BY:	GBM	FRONT ELEVATION REAR ELEVATION
	DATE:	AUG. 1, 1989	ISSUED ON: JAN. 4, 2017	LOCATION:	ADDRESS: GEN. SANTOS AVE., BICUTAN, TAGUIG CITY, METRO MANILA				APPROVED BY :		ROOF PLAN
	TIN:	106-459-911	ISSUED AT: PASIG CITY	GEN. SANTOS AVE., BICUTAN, TAGUIG CITY, METRO MANILA					DATE:		


DRAWING NO

SHEET NO. :

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- 1. ALL DIMENSIONS SHOWN HEREIN ARE IN MILLIMETERS UNLESS OTHERWISE NOTED.
- 2. FOR PLAN & ELEVATIONS, REFER TO DRAWING NO. A-6.




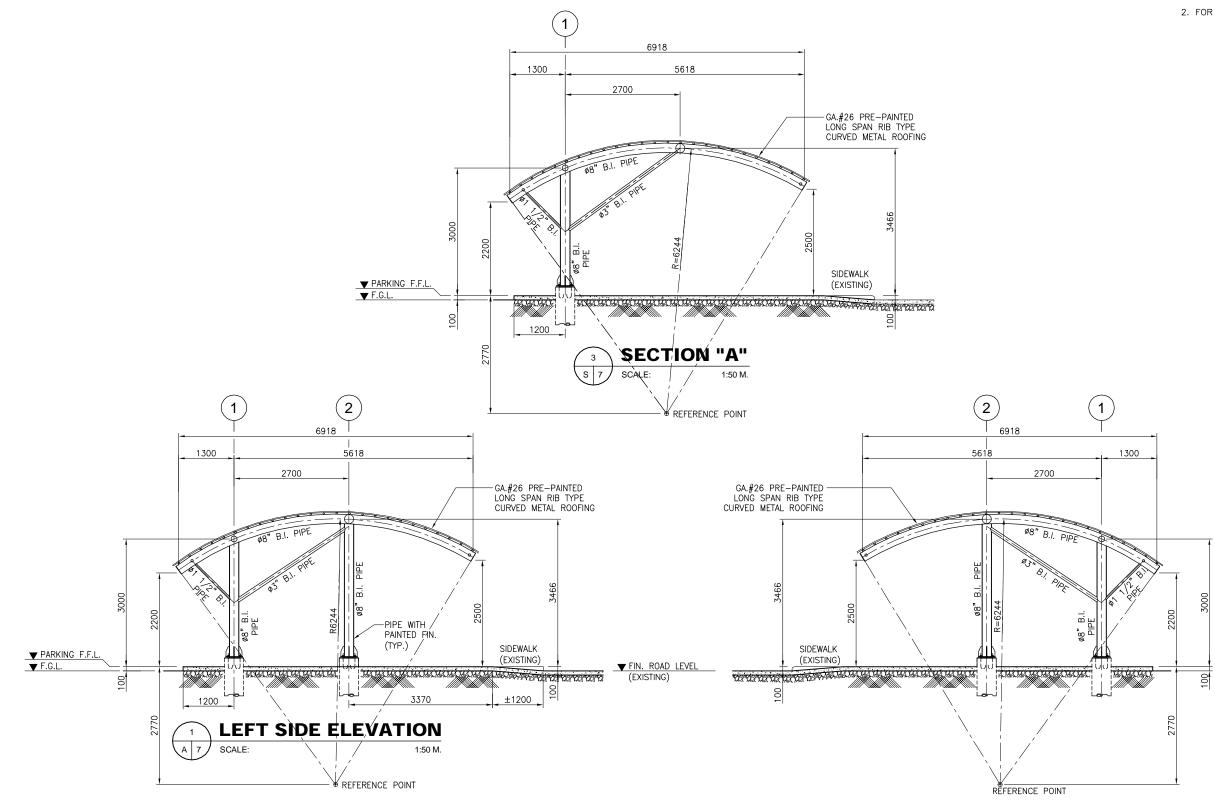


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				DDODOCED COVEDED WALKWAY DADKING	METAL INDUSTRY RESEARCH AND				CADD BY:	RHV	<u>co</u>
	GILBERT B. MAGBUTAY		s. MAGBUTAY	PROPOSED COVERED WALKWAY, PARKING AND DOST NORTH GATE SIGNAGE	DEVELOPMENT CENTER (MIRDC)				DATE:		٦.,
	REG. NO.:	055251	PTR NO.: 2321899						CHECKED BY:	GBM	- LE
	DATE:	AUG. 1, 1989	ISSUED ON: JAN. 4, 2017	LOCATION:	ADDRESS:				APPROVED BY:		SE
	TIN:	106-459-911	ISSUED AT: PASIG CITY	GEN. SANTOS AVE., BICUTAN, TAGUIG CITY, METRO MANILA	GEN. SANTOS AVE., BICUTAN, TAGUIG CITY, METRO MANILA				DATE:		

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COVERED CAR PARK LEFT SIDE ELEVATION	A - 7
RIGHT SIDE ELEVATION	SHEET NO.:
SECTION "A"	7 / 22

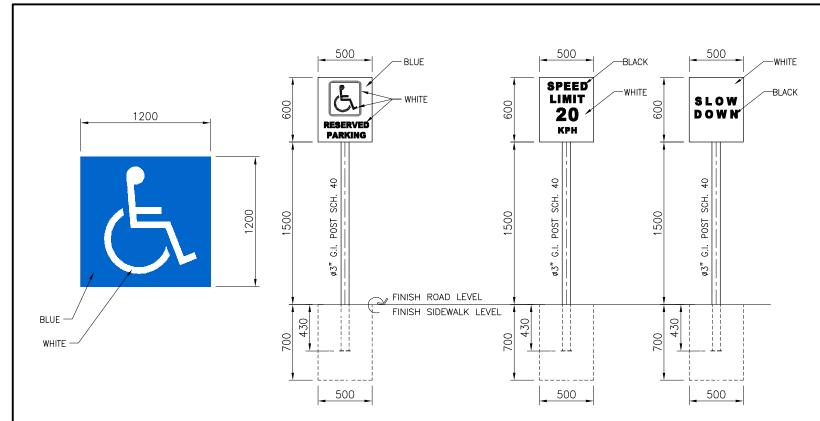


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TYPICAL PARKING SIGNAGE DETAILS SCALE: 1:20 M.



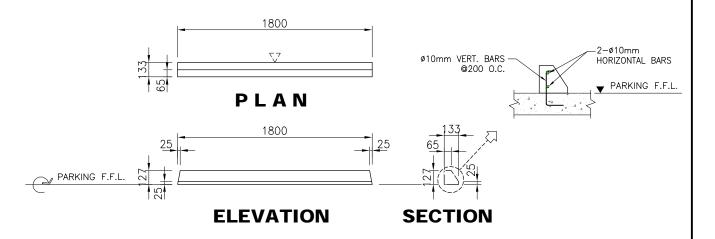


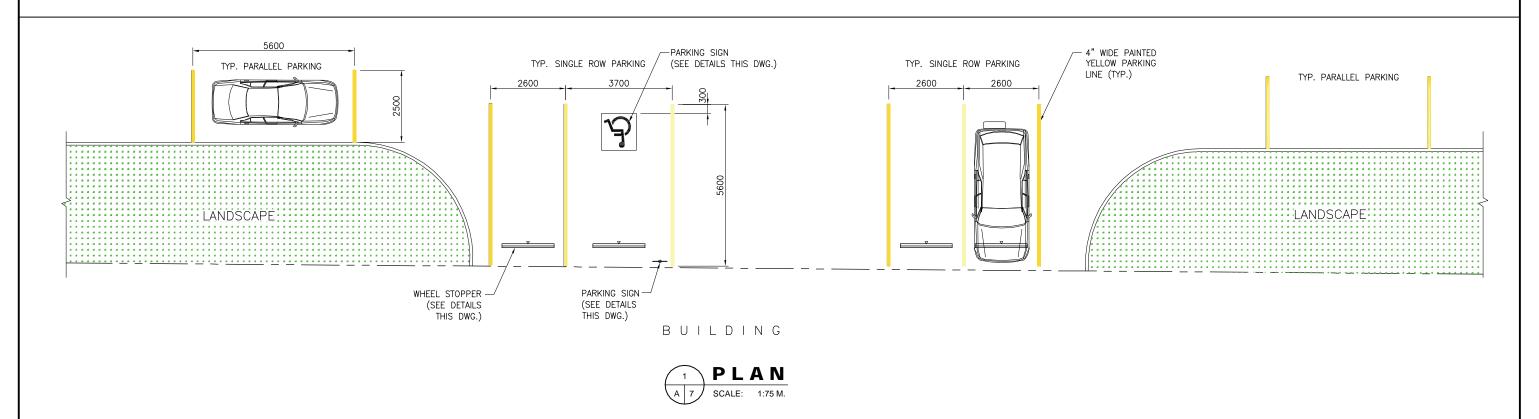


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CIVIL	STRUCTURAL ENGINE	EER:	PROJECT TITLE :	OWNER:	DATE:	REVISION:	DESCRIPTION:	DESIGNED BY:		SHEET CONTENTS:	DRAWING NO.:
	GILBERT B. MAGBUTAY		PROPOSED COVERED WALKWAY BARKING	METAL INDUSTRY RESEARCH AND DEVELOPMENT CENTER (MIRDC)				CADD BY:	RHV	OPEN CAR PARKING	Λ Q
			PROPOSED COVERED WALKWAY, PARKING AND DOST NORTH GATE SIGNAGE					DATE:			A - 0
REG.	NO.: 055251	PTR NO.: 2321899						CHECKED BY:	GBM	PLAN TYPICAL DETAILS	SHEET NO. :
DATE	AUG. 1, 1989	ISSUED ON: JAN. 4, 2017	LOCATION:	ADDRESS:				APPROVED BY:		TIPICAL DETAILS	8 / 22
TIN:	106-459-911	ISSUED AT: PASIG CITY	GEN. SANTOS AVE., BICUTAN, TAGUIG CITY, METRO MANILA	GEN. SANTOS AVE., BICUTAN, TAGUIG CITY, METRO MANILA				DATE:			0 / 22



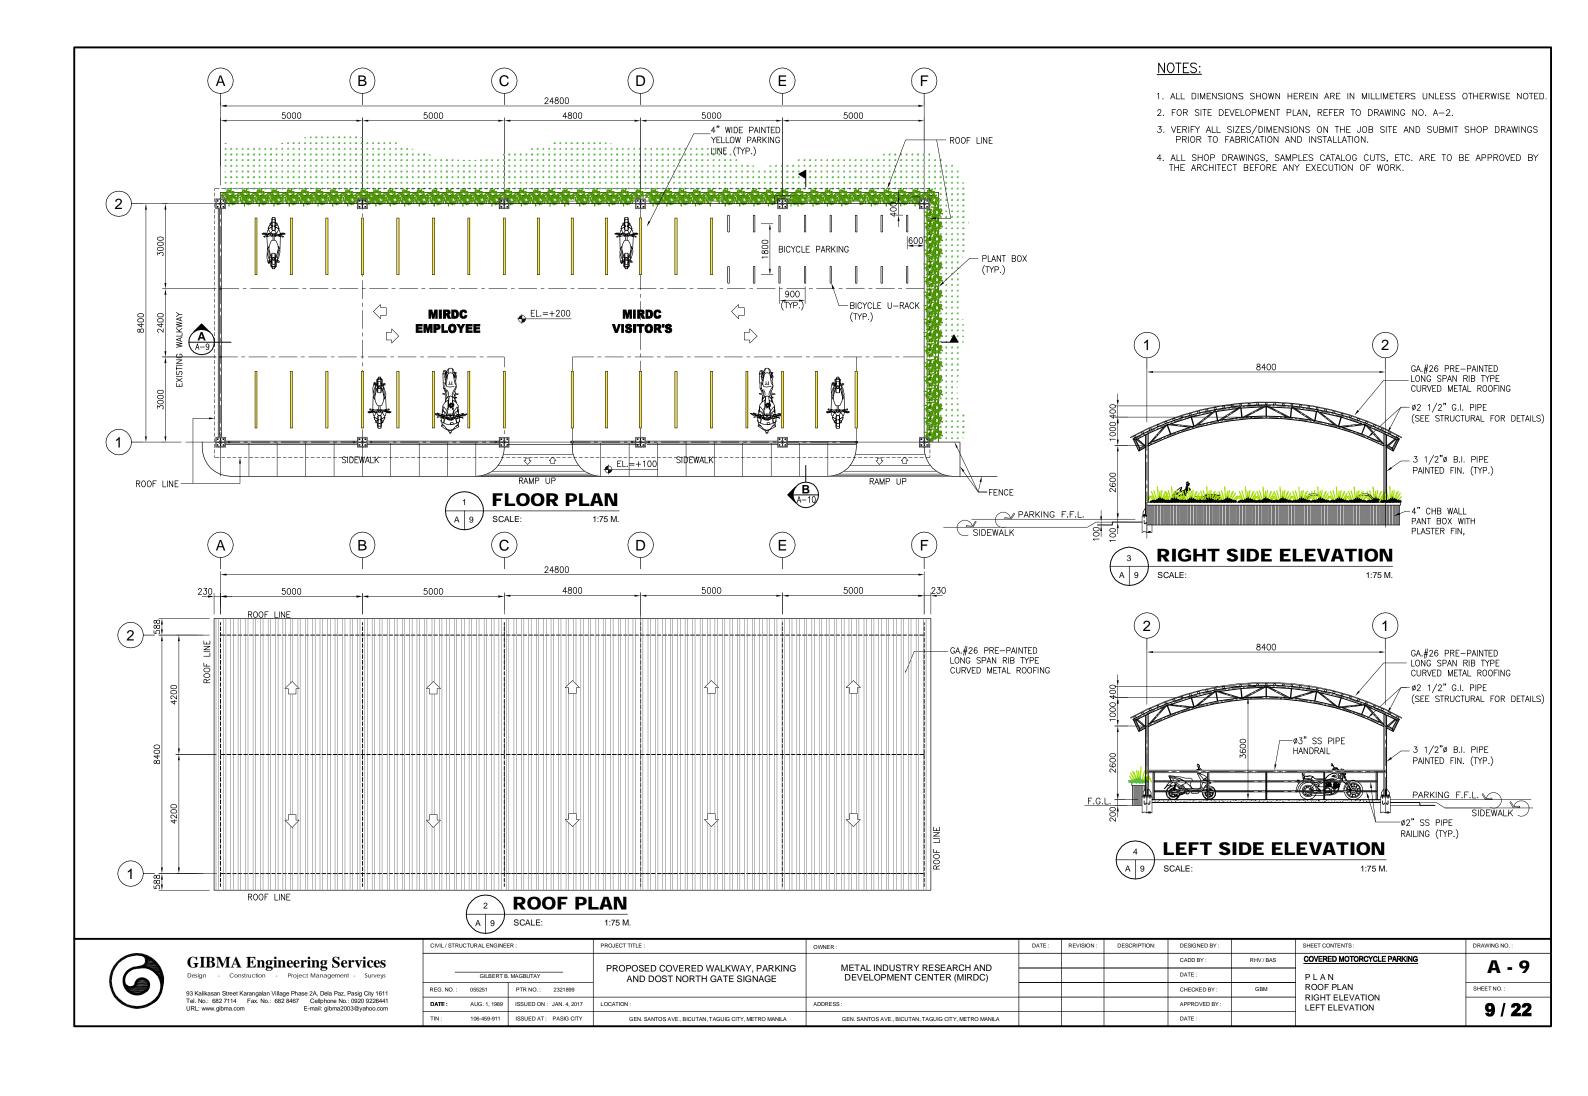

GENERAL NOTES

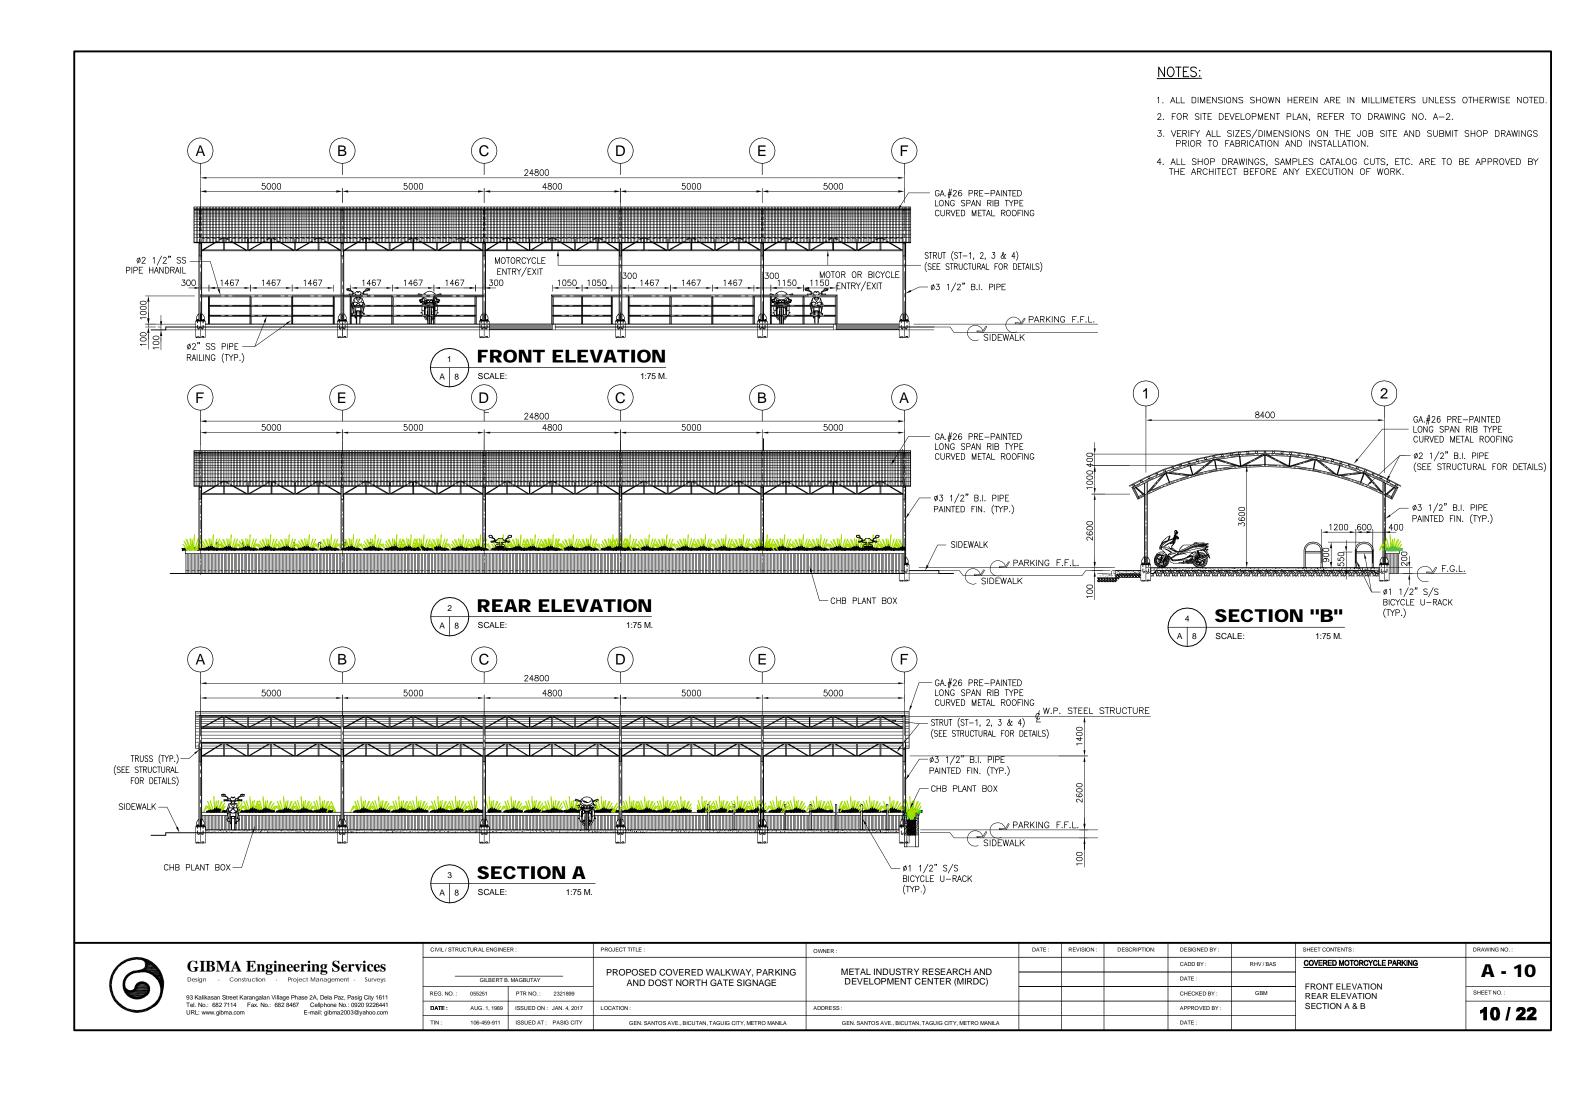1. GENERAL

1.1 SETTING OUT

ALL NECESSARY BOUNDARY LINES, BUILDING LINES AND CORNER PEGS SHALL BE ESTABLISHED AND APPROVED BY A REGISTERED GEODETIC

ALL DIMENSIONS MEASURED ON SITE SHALL BE CHECKED AND CONFIRMED WITH RELEVANT ARCHITECTURAL, STRUCTURAL AND M&E

ALL DISCREPANCIES IN THE DIMENSIONS SHALL BE BROUGHT TO THE ATTENTION OF THE ARCHITECT/ ENGINEER PRIOR TO THE ORDERING OF MATERIAL AND COMMENCEMENT OF CONSTRUCTION OF THE RELEVANT WORKS

1.2 LEVELS

ALL NECESSARY REDUCED LEVELS OF THE EXISTING SITE AND PROPOSED BUILDING FORMATION LEVELS SHALL BE ESTABLISHED WITH REFERENCE TO APPROVED BENCH MARKS. ALL LEVELS SHOWN ARE IN METRIC MEASUREMENT

ANY DISCREPANCIES IN THE MEASURED LEVELS AND THE LEVELS STATED IN THE RELEVANT ARCHITECTURAL DRAWINGS SHALL BE BROUGHT TO THE IMMEDIATE ATTENTION OF THE ARCHITECT/

1.3 DRAWINGS ALL STRUCTURAL DRAWINGS SHALL BE READ IN CONJUNCTION WITH RELEVANT ARCHITECTURAL DRAWINGS AND SPECIFICATION.
ANY DISCREPANCIES BETWEEN DRAWINGS SHALL BE BROUGHT TO THE ATTENTION OF THE ARCHITECT/ ENGINEER.

THE LATEST REVISIONS IN THE DRAWINGS SHALL BE INCORPORATED IN THE CONSTRUCTION WORKS

1.4 INCORPORATION OF M&E REQUIREMENTS IN STRUCTURE THE CONTRACTOR SHALL INCORPORATE ALL MECHANICAL, SANITARY AND ELECTRICAL WORKS TO BE EMBEDDED IN THE CONCRETE OR OPENINGS FOR PIPE OR DUCT WORKS BASED IN THE REQUIREMENTS OF M&F DRAWINGS IN HIS POSSESSION. HE SHALL CHECK THE M&F. DRAWINGS AND RESOLVE DISCREPANCIES, IF ANY, BEFORE CONCRETING.

ANY DEVIATIONS IN THE STRUCTURAL WORK DUE TO SERVICES REQUIREMENTS SHALL BE BROUGHT TO THE ATTENTION OF THE ARCHITECT/ ENGINEER FOR HIS APPROVAL.

2. SUBSTRUCTURE WORKS

2.1 EARTHWORKS
ALL EARTHWORKS SHALL BE IN ACCORDANCE WITH THE REQUIREMENTS OF STRUCTURAL AND ARCHITECTURAL DRAWINGS AND

FOR ALL EXCAVATIONS INCLUDING BUT NOT LIMITED TO FOOTINGS. PITS AND TRENCHES BELOW GROUND LEVEL, CULVERTS AND DRAIN PIPE TRENCHES, THE CONTRACTOR SHALL BE RESPONSIBLE FOR THE DESIGN AND PROVISION OF ADEQUATE SHORING AND STRUTTING TO THE SATISFACTION OF THE ARCHITECT/ENGINEER. DETAILS OF THE SHORING AND STRUTTING SHALL BE SUBMITTED TO THE ARCHITECT/

2.2 LEAN CONCRETE UNLESS OTHERWISE STATED, A MINIMUM OF 50mm THICK LEAN CONCRETE LAYER SHALL BE PROVIDED ON ALL SOIL SURFACES FORMING THE UNDERSIDE OF ANY REINFORCED FOOTINGS, BEAMS, SLABS, SUMP PITS, DRAINS, FTC

3. MATERIALS AND WORKMANSHIP

3.1 STANDARDS AND SPECIFICATIONS

WHERE APPLICABLE, ALL MATERIALS AND WORKMANSHIP SHALL CONFORM TO THE LATEST EDITION OF THE RELEVANT CODES:

NATIONAL BUILDING CODE OF THE PHILIPPINES ACI 318 - 2008

D AISC

3.2 MATERIAL STRENGTHS

3.2.1 CONCRETE UNLESS OTHERWISE STATED ON THE DRAWINGS, THE GRADE OF CONCRETE SHALL BE AS FOLLOWS:

LEAN OR MASS CONCRETE

FOOTINGS, FOOTING TIE BEAMS, COLUMNS

SUSPENDED BEAMS AND SLABS, GIRDERS, PARAPET WALLS 3,000 psi : 2.500 psi

SLAB-ON-GRADE, CATCH BASIN, AREA DRAIN

3.2.2 STEEL REINFORCEMENT

THE MINIMUM YIELD STRENGTH OF STEEL REINFORCEMENT SHALL BE AS FOLLOWS:

DEFORMED BARS Ø16mm AND BIGGER 275 MPa DEFORMED BARS Ø12mm AND SMALLER

3.2.3 STRUCTURAL STEEL

ALL STRUCTURAL STEELWORKS SHALL CONFORM TO GRADE 36 STEEL UNLESS OTHERWISE SPECIFIED.

ALL STRUCTURAL STEEL WORKS SHALL BE CARRIED OUT CONFORMING TO THE LATEST EDITION OF THE AISC AND RELEVANT PROVISIONS OF THE NSCP.

3.3 WORKMANSHIP

CONCRETE COVER TO ALL REINFORCEMENT INCLUDING STIRRUPS (UNLESS OTHERWISE SHOWN ON DRAWINGS), SHALL BE NOT LESS

EXPOSED TO WEATHER OR IN CONTACT

WITH EARTH	: 70	mm (
SLABS	: 20	mm (
BEAM SOFFIT AND SIDES	: 40	mm (
COLUMNS	: 40	mm (
WALLS	: 20	mm (
FOOTINGS	: 75	5 mm

3.4 LAPS AND SPLICES (UNLESS OTHERWISE SPECIFIED)

TENSION LAP,mm	COMPRESSION LAP,mm
520	400
625	480
835	640
1,040	800
1,300	1,000
1,665	1,280
	520 625 835 1,040 1,300

NO SPLICES SHALL BE MADE AT POINT OF MAXIMUM STRESS, I.E., TOP BARS IN BEAMS AND SLABS SHOULD NOT BE SPLICED AT MIDSPAN AND BOTTOM BARS AT SUPPORTS. SPLICES SHALL BE STAGGERED WHEREVER POSSIBLE

CRANKING OF COLUMN BARS SHOULD NOT EXCEED A SLOPE OF 1 IN 10 WHENEVER POSSIBLE. NOT MORE THAN 50% OF COLUMN BARS SHOULD BE SPLICED AT ONE SECTION.

4. STANDARD PROVISIONS

REGARDLESS OF WHETHER OR NOT SHOWN IN DRAWINGS AND OTHER TENDER DOCUMENTS, THE FOLLOWING STANDARD PROVISIONS ARE CONSIDERED PART OF THE CONTRACT AND SHALL BE CARRIED OUT UNLESS OTHERWISE STATED.

4.1 STARTER BARS FOR WALLS AND COLUMNS

STARTER BARS FROM THE STRUCTURAL SYSTEM FOR R.C. WALLS AND COLUMNS SHALL CORRESPOND IN NUMBER AND SIZE TO THE REINFORCEMENT IN THE WALL OR COLUMN IN WHICH THEY ARE TO BE EMBEDDED. ALL STARTER BARS FOR WORKS NOT TO BE CARRIED OUT AT LEAST FOR ONE MONTH SHALL BE PROTECTED WITH 2 COATS OF CEMENT WASH. THE COATING SHALL BE MAINTAINED PERIODICALLY TO ENSURE PROTECTION TO THE REINFORCEMENT. BARS SHALL NOT BE BENT OR OTHERWISE DAMAGED WHILE THEY ARE EXPOSED.

4.2 CONSTRUCTION JOINTS

THE LOCATION OF CONSTRUCTION JOINTS AND THE CONCRETE CASTING PLAN SHALL BE SUBJECTED TO THE APPROVAL OF THE

4.3 R.C. STIFFENERS FOR CONCRETE MASONRY WALLS


R.C. STIFFENERS FOR CONCRETE MASONRY WALLS AND STARTER BARS THEREFROM SHALL BE PROVIDED AS PER ARCHITECTURAL DRAWINGS, UNLESS OTHERWISE STATED:


FOR MASONRY WALLS 3.0m HIGH, USE 150mm X 300mm STIFFENER BEAMS AND COLUMNS REINFORCED WITH 4-Ø16 AND Ø10 @ 200mm O.C. SPACING OF STIRRUPS/LATERAL TIES. STIFFENERS SHALL BE SPACED AT NOT MORE THAN 5m APART

5. CRITICAL CONSTRUCTION PROCEDURE

5.1 TO MINIMIZE CRACKING DUE TO SHRINKAGE IN THE LARGE AREA SLABS AND WALLS, THE CONTRACTOR SHALL PROVIDE SHRINKAGE JOINTS (POUR STRIPS) AT APPROPRIATE INTERVALS AS APPROVED BY THE ARCHITECT/ ENGINEER. THE JOINTS SHALL NOT BE CONCRETED UNTIL AT LEAST 7 DAYS AFTER THE ADJACENT CONCRETE PANELS HAVE

5.2 CONCRETE IN FLOOR SLABS SHALL BE LAID TO FALLS AS SHOWN IN THE ARCHITECTURAL DRAWINGS DURING THE INITIAL CASTING OF THE

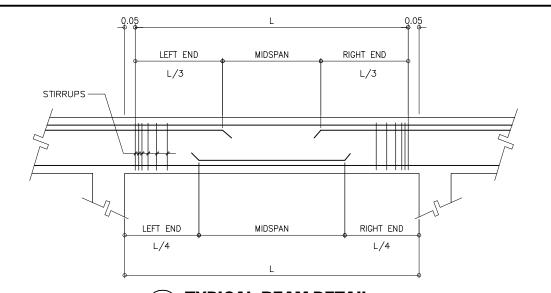

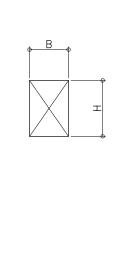

BOTTOM BARS AT EAST-WEST DIR.

TOP BARS EAST SIDE

TOP BARS AT SOUTH SIDE


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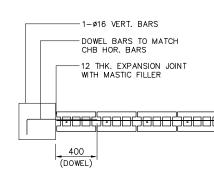
11 / 22

TYPICAL BEAM DETAIL



BOTTOM BARS AT NORTH-SOUTH DIR.

TOP BARS AT NORTH SIDE H

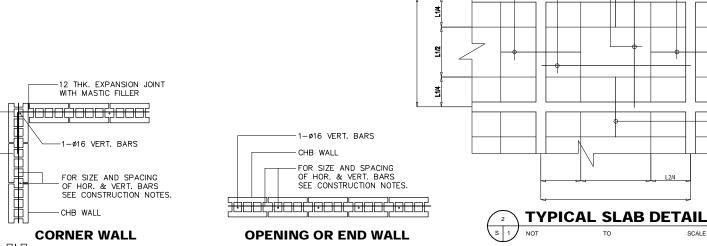

INTERSECTION WALL

CHB WALL

1-ø16 VERT. BARS

-12 THK EXPANSION JOINT

FOR SIZE AND SPACING

OF HOR. & VERT. BARS

SEE CONSTRUCTION NOTES.

INTERSECTING R.C. COL. OR WALL







GIBMA Engineering Services Project Management

: 1,500 psi

SHEET CONTENTS:
GENERAL NOTES
MASONRY WALL TYPICAL SLAB DETAIL
TYPICAL BEAM DETAIL
GEN MAS

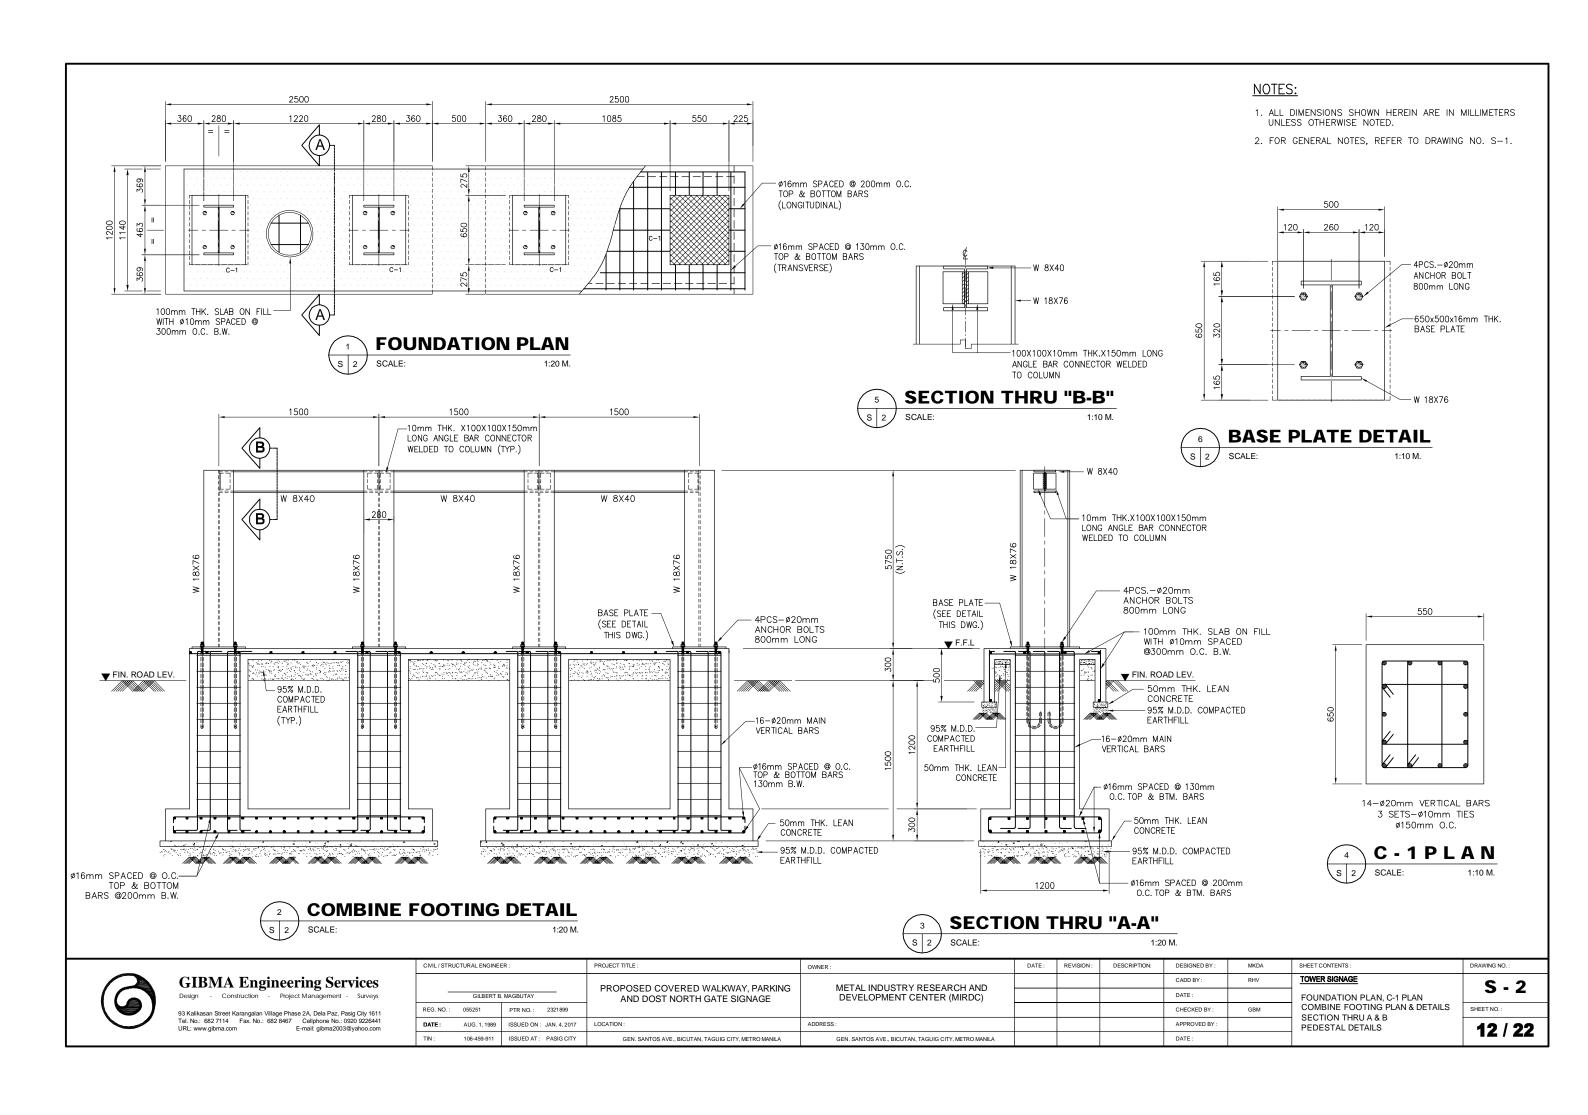

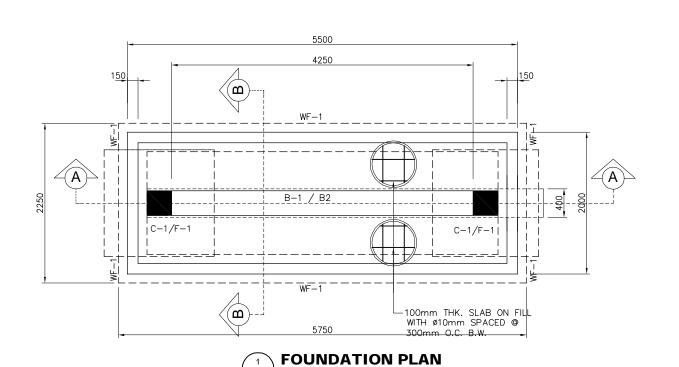

SCALE:

SCHEDULE OF FOOTING

		FOOTING	NUMBER OF Ø16mm REBARS			
FOOTING DESIGNATION	X	Y	THICKNESS		ALONG Y	
	mm	mm	mm	ALONG X		
F-1	1500	1500	300	9 - Ø16	9 - Ø16	

NOTES:

- 1. ALL DIMENSIONS SHOWN HEREIN ARE IN MILLIMETERS UNLESS OTHERWISE NOTED.
- 2. FOR GENERAL NOTES, REFER TO DRAWING NO. S-1.

DRAWING NO

SHEET NO.:

S-3


13 / 22

SCHEDULE OF COLUMN

COLUMN MARKING	LEVEL	SECTION (B X H)	MAIN VERT. REBARS	Ø10 LATERALTIES		
C-1	FOOTING TO BEAM 2	350 X 350	8 – Ø16	2SETS @ 150 o.c.		

SCHEDULE OF BEAMS

BEAM	SECTION	BEAM TYPE	LEFT ENI	D REBARS	MIDSPA	N REBARS	RIGHT EN	D REBARS	SPACING OF Ø10 STIRRUPS	
MARKING	(B x H)	BEAWTITE	TOP	воттом	TOP	воттом	TOP	воттом	TO CENTER	
B-1	350 X 600	SINGLE	3-ø16	2-ø16	3-ø16	2-ø16	3-ø16	2-ø16	1 @ 50, 3 @ 100,REST @ 120 1 @ 50, 3 @ 100,REST @ 120	
B-2	350 X 300	SINGLE	4-ø16	3-ø16	4-ø16	3-ø16	4-ø16	3-ø16		

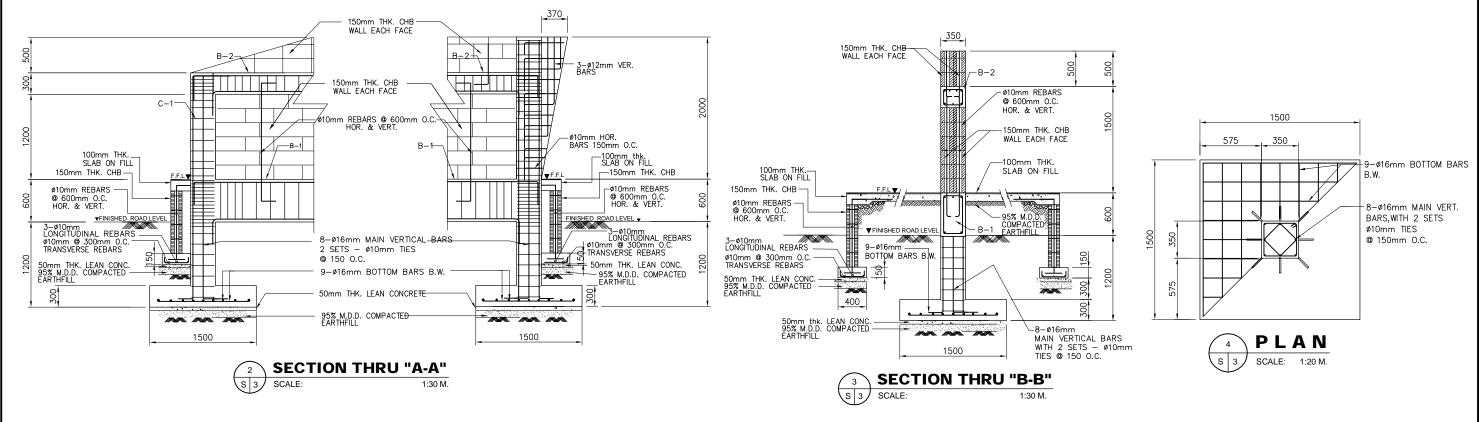





GIBMA Engineering Services Design - Construction - Project Management - Surveys

CIVIL / STRUCTURAL ENGINEER:		R:	PROJECT TITLE :	OWNER:		REVISION:	DESCRIPTION:	DESIGNED BY:		SHEET CONTENTS:		
		PROPOSED COVERED WALKWAY, PARKING METAL INDUSTRY RESEARCH AND					CADD BY:	RHV	GROUND SIGNAGE			
	_	GILBERT B	. MAGBUTAY	AND DOST NORTH GATE SIGNAGE	DEVELOPMENT CENTER (MIRDC) ADDRESS:				DATE:		FOUNDATION PLAN & DETAILS SECTION THRU "A" & "B" SCHEDULES OF FOOTING, COLUMN	
	REG. NO.:	055251	PTR NO.: 2321899						CHECKED BY:	GBM		
	DATE:	AUG. 1, 1989	ISSUED ON: JAN. 4, 2017	LOCATION:					APPROVED BY :		& BEAMS	
	TIN:	106-459-911	ISSUED AT: PASIG CITY	GEN. SANTOS AVE., BICUTAN, TAGUIG CITY, METRO MANILA	GEN. SANTOS AVE., BICUTAN, TAGUIG CITY, METRO MANILA				DATE :			





- 1. ALL DIMENSIONS SHOWN HEREIN ARE IN MILLIMETERS UNLESS OTHERWISE NOTED.
- 2. FOR GENERAL NOTES, REFER TO DRAWING NO. S-1.

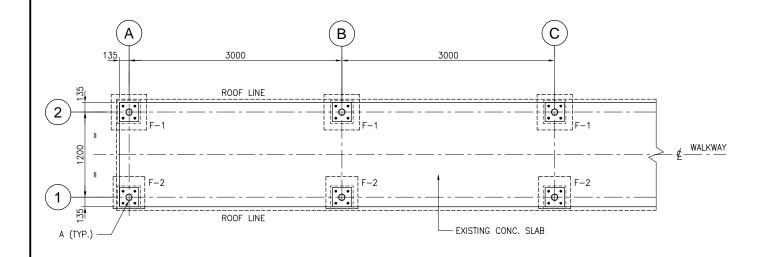


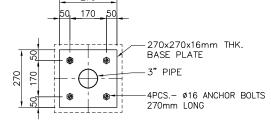



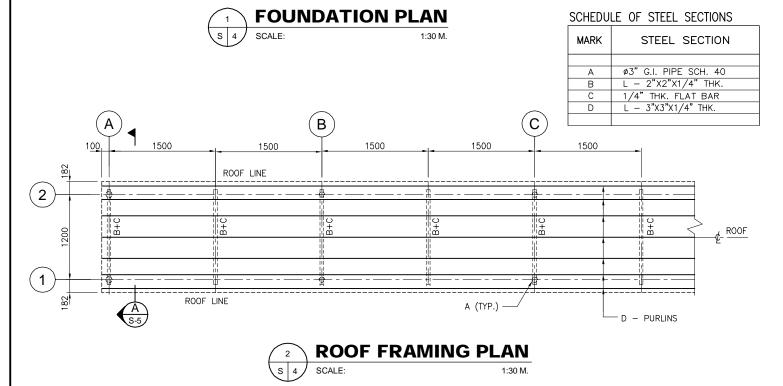

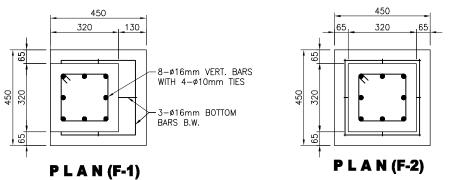

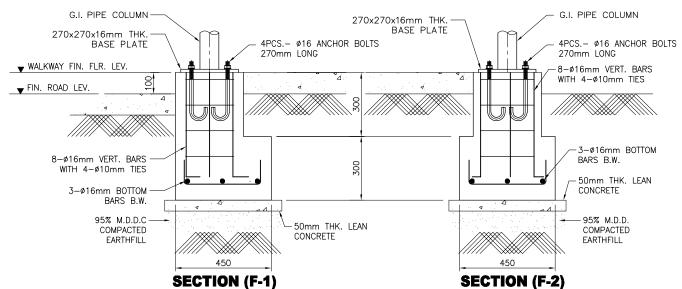


FOOTING DETAILS S 4 SCALE: 1:10 M.



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CIVIL / STRUCTURAL ENGINEER:		CIVIL/ STRUCTURAL ENGINEER: PROJECT TITLE:		OWNER:	DATE:	REVISION:	DESCRIPTION:	DESIGNED BY:	JBNN	SHEET CONTENTS:	DRAWING NO.:	
			DRODOCED COVERED WALKWAY DARKING	METAL INDUSTRY RESEARCH AND DEVELOPMENT CENTER (MIRDC)				CADD BY:	RHV	COVERED WALKWAY	0 1	
-	GILBERT B	B. MAGBUTAY	PROPOSED COVERED WALKWAY, PARKING AND DOST NORTH GATE SIGNAGE					DATE:		FOUNDATION PLAN	3-4	
REG. NO.:	055251	PTR NO.: 2321899						CHECKED BY:	GBM	ROOF FRAMING PLAN	SHEET NO.:	
DATE:	AUG. 1, 1989	ISSUED ON: JAN. 4, 2017	LOCATION:	ADDRESS:				APPROVED BY :		FOOTING & BASE PLATE DETAILS	14 / 22	
TIN:	106-459-911	ISSUED AT: PASIG CITY	GEN. SANTOS AVE., BICUTAN, TAGUIG CITY, METRO MANILA	GEN. SANTOS AVE., BICUTAN, TAGUIG CITY, METRO MANILA				DATE:			17/22	



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	ject Management - Surveys					
93 Kalikasan Street Karangalan Village Ph Tel. No.: 682 7114 Fax. No.: 682 846 URL: www.gibma.com						

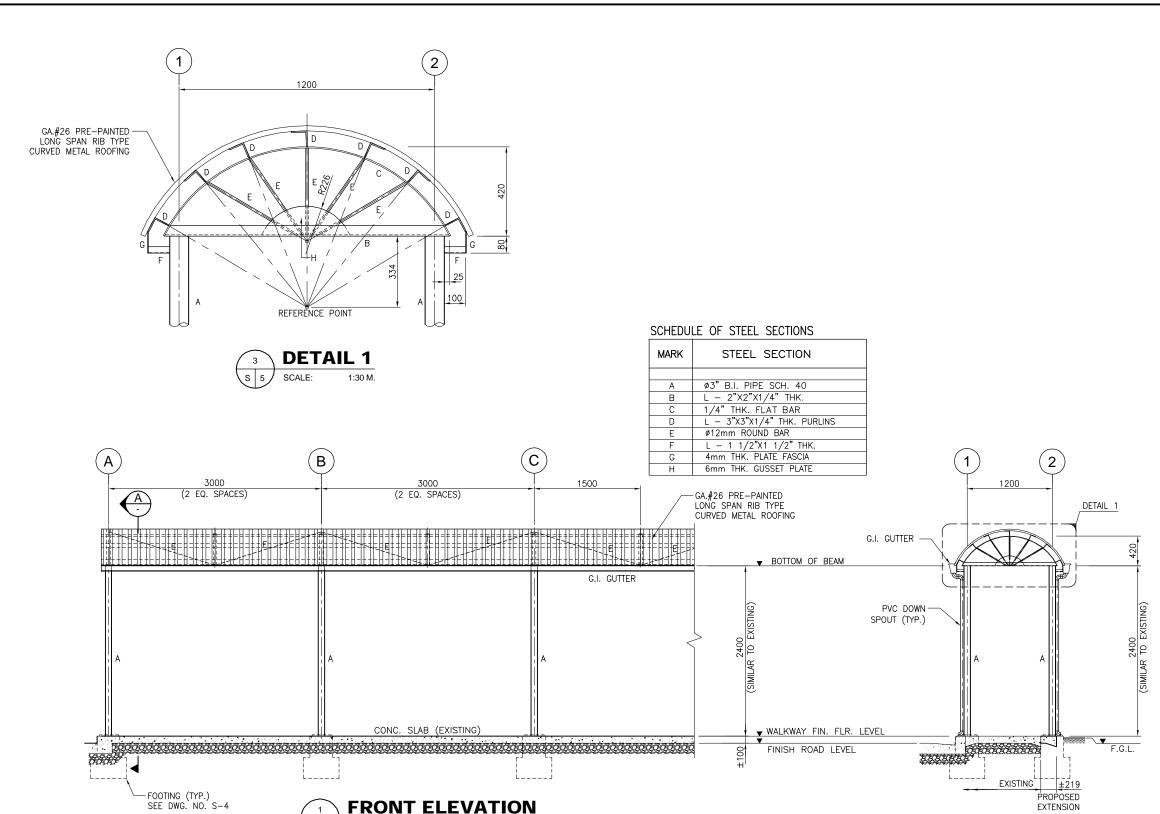CIVIL / STRUCTURAL ENGINEER:		ER:	PROJECT TITLE :	OWNER:	DATE :	REVISION:	DESCRIPTION:	DESIGNED BY:	JBNN	SHEET CONTENTS:	
			DRODOCED COVEDED WALKWAY DADKING	METAL INDUSTRY RESEARCH AND				CADD BY:	RHV	COVERED WALKWAY	
_	GILBERT B	s. MAGBUTAY	PROPOSED COVERED WALKWAY, PARKING AND DOST NORTH GATE SIGNAGE	DEVELOPMENT CENTER (MIRDC)				DATE:		FRONT ELEVATION	
REG. NO.:	055251	PTR NO.: 2321899						CHECKED BY:	GBM	SECTION "A"	
DATE:	AUG. 1, 1989	ISSUED ON: JAN. 4, 2017	LOCATION:	ADDRESS:				APPROVED BY :		DETAIL 1	
TIN:	106-459-911	ISSUED AT: PASIG CITY	GEN. SANTOS AVE., BICUTAN, TAGUIG CITY, METRO MANILA	GEN. SANTOS AVE., BICUTAN, TAGUIG CITY, METRO MANILA				DATE:			

SECTION "A"

SCALE:

NOTES:


- 1. ALL DIMENSIONS SHOWN HEREIN ARE IN MILLIMETERS UNLESS OTHERWISE NOTED.
- 2. FOR GENERAL NOTES, REFER TO DRAWING NO. S-1.

DRAWING NO.


SHEET NO.:

S-5

15 / 22

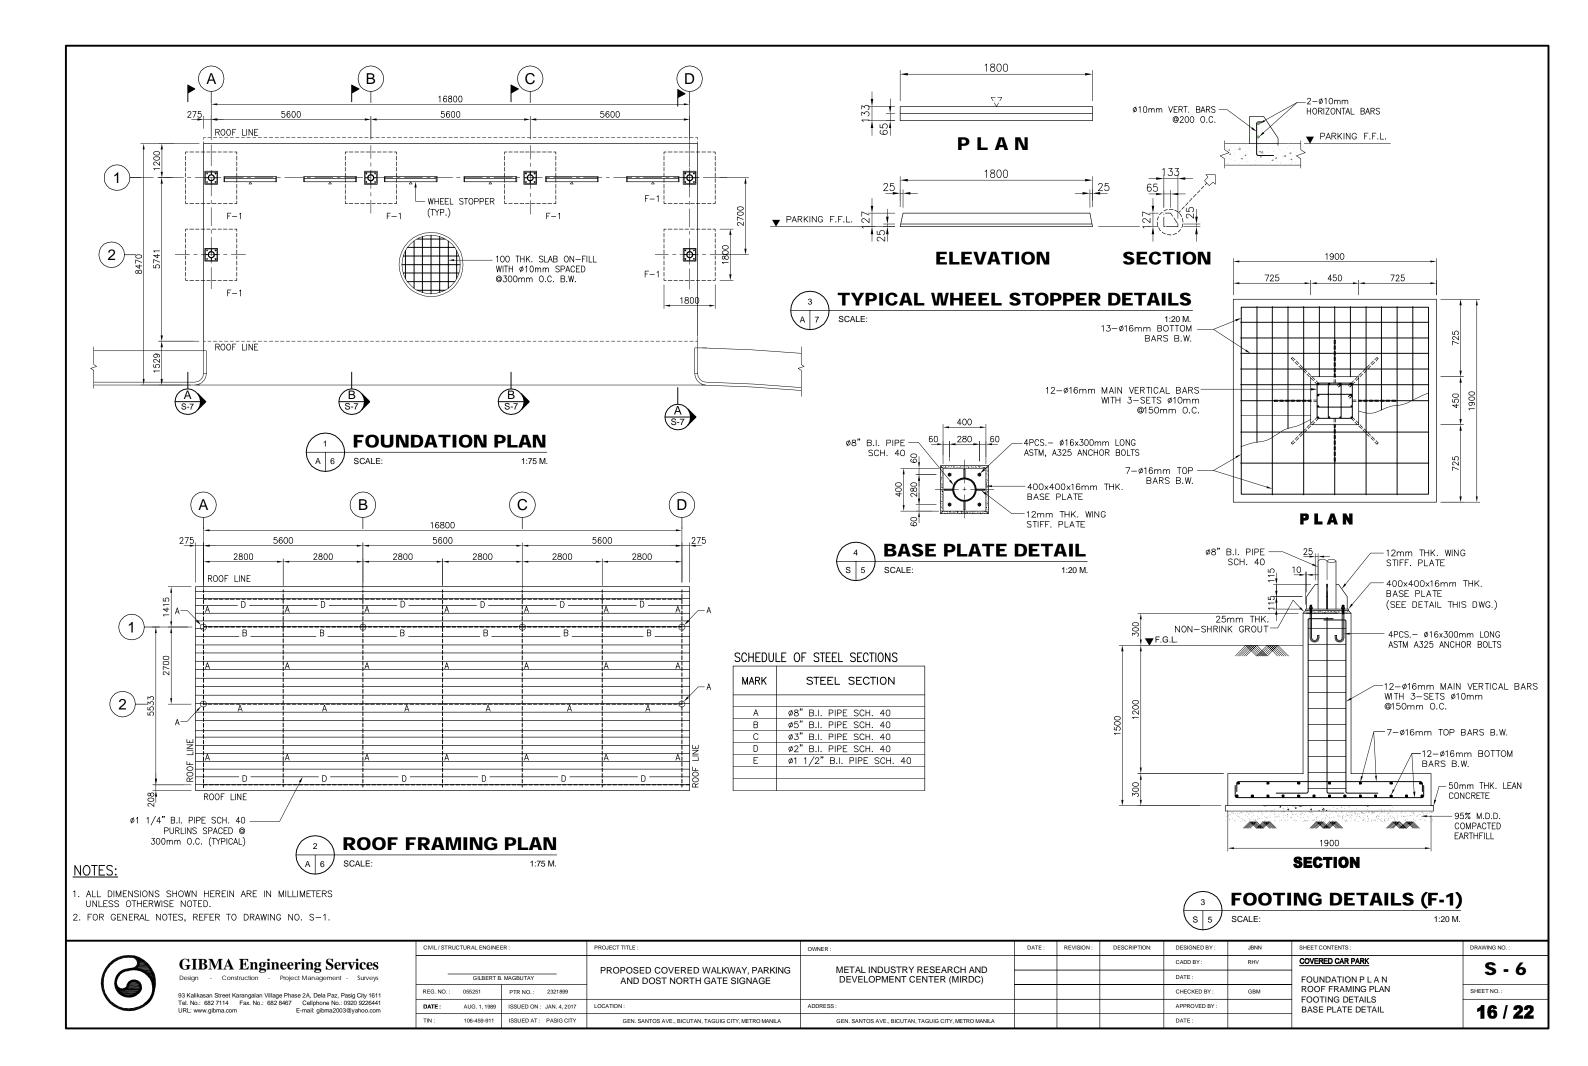

- 1. ALL DIMENSIONS SHOWN HEREIN ARE IN MILLIMETERS UNLESS OTHERWISE NOTED.
- 2. FOR GENERAL NOTES, REFER TO DRAWING NO. S-1.

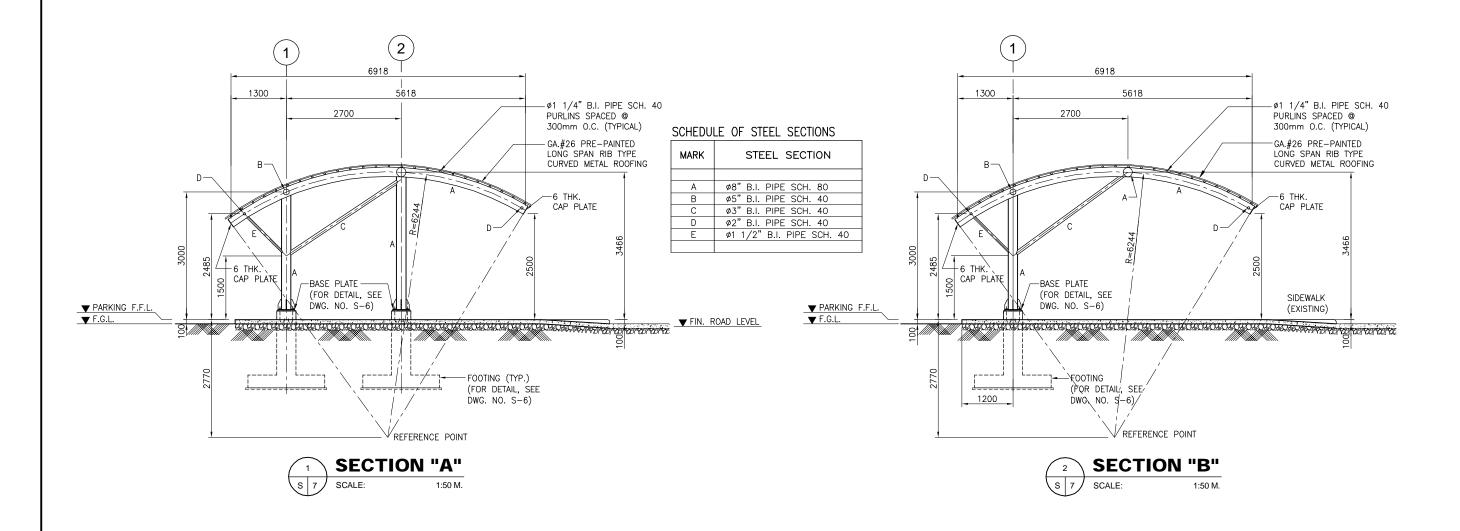




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CIVIL / STRUCTURAL ENGINEER:		ER:	PROJECT TITLE :	OWNER:		REVISION:	DESCRIPTION:	DESIGNED BY:	JBNN	SHEET C
			DRODOSED COVERED WALKWAY DARKING	METAL INDUSTRY RESEARCH AND				CADD BY:	RHV	COVER
_	GILBERT E	S. MAGBUTAY	PROPOSED COVERED WALKWAY, PARKING AND DOST NORTH GATE SIGNAGE	DEVELOPMENT CENTER (MIRDC)				DATE:		
REG. NO.:	055251	PTR NO.: 2321899						CHECKED BY:	GBM	SECT SECT
DATE:	AUG. 1, 1989	ISSUED ON: JAN. 4, 2017	LOCATION:	ADDRESS:				APPROVED BY :		SEC
TIN:	106-459-911	ISSUED AT: PASIG CITY	GEN. SANTOS AVE., BICUTAN, TAGUIG CITY, METRO MANILA	GEN. SANTOS AVE., BICUTAN, TAGUIG CITY, METRO MANILA				DATE:		

SHEET CONTENTS:	DRAWING NO.:
COVERED CAR PARK	S - 7
	3.7
SECTION "A" SECTION "B"	SHEET NO.:
SECTION B	17 / 22



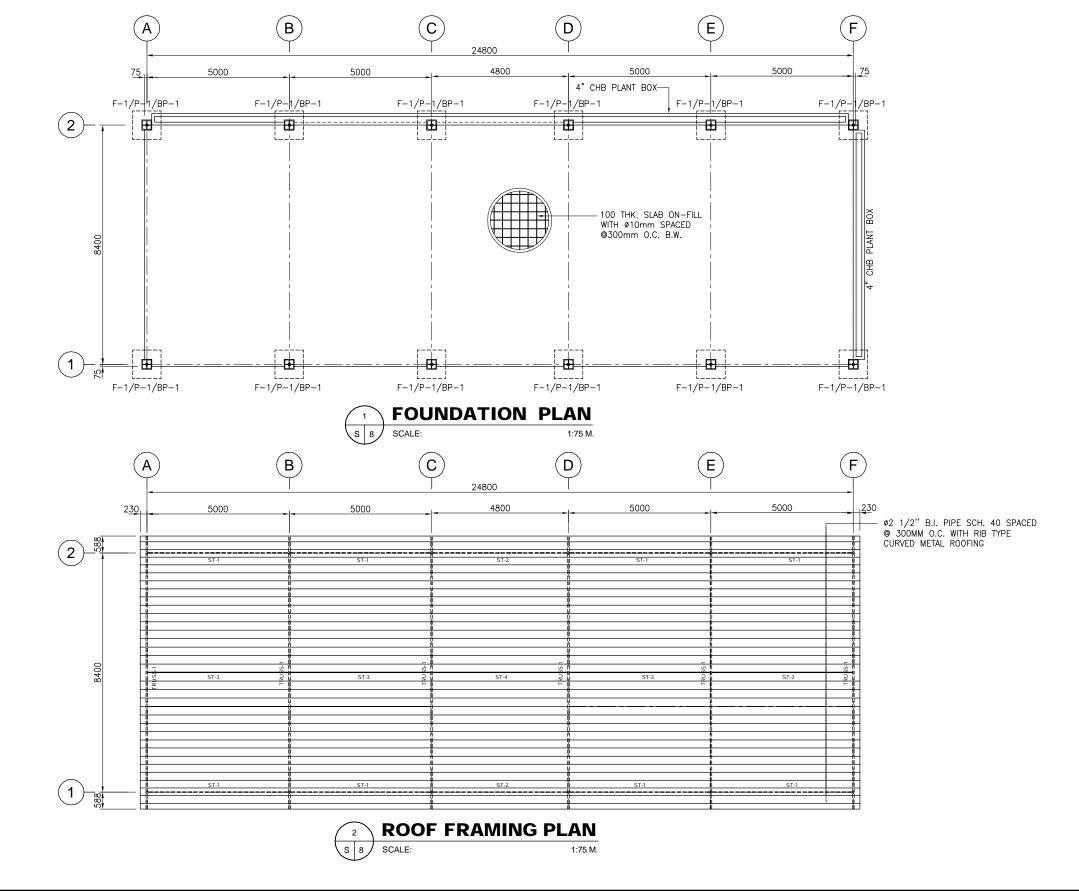

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93 Kalikasan Street Karangalan Village Phase 2A, Dela Paz, Pasig City 1611
Tel. No.: 682 7114 Fax. No.: 682 8467 Cellphone No.: 0920 9226441
URL: www.gibma.com E-mail: gibma2003@yahoo.com

JBNN
BAS
GBM

NOTES:

- 1. ALL DIMENSIONS SHOWN HEREIN ARE IN MILLIMETERS UNLESS OTHERWISE NOTED.
- 2. FOR GENERAL NOTES, REFER TO DRAWING NO. S-1.

SHEET CONTENTS:

COVERED MOTORCYCLE PARKING

FOUNDATION PLAN


ROOF FRAMING PLAN

DRAWING NO.:

SHEET NO.

S - 8

18 / 22

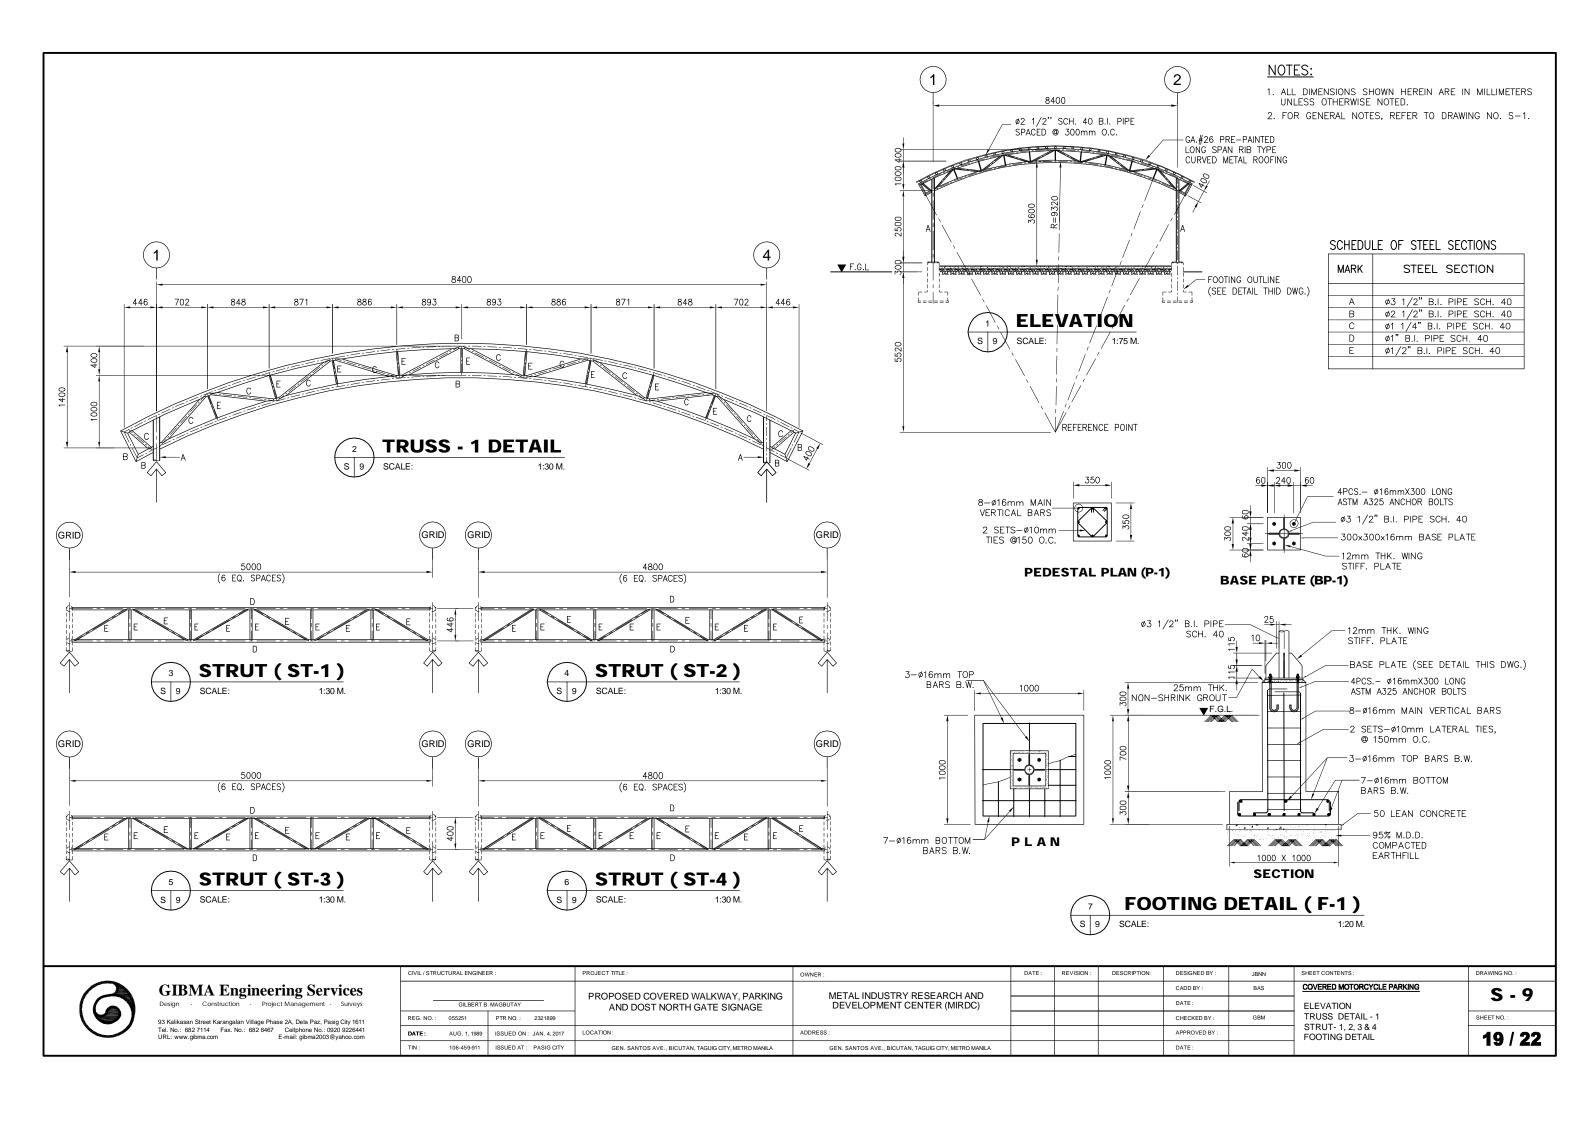

GENERAL NOTES:

- 1. ALL ELECTRICAL WORKS SHALL BE DONE IN ACCORDANCE WITH THE PERTINENT PROVISIONS OF THE LATEST EDITION OF THE PHILIPPINE ELECTRICAL CODE.
- LOCATION OF LIGHTING FIXTURES ARE APRROXIMATE ONLY. FINAL PROVISIONS SHALL BE DETERMINED ON SITE TO AVOID INTERFERENCE WITH OTHER SYSTEM AND/OR EQUIPMENTS.
- 3. METALLIC FRAMES OF EQUIPMENTS SHALL BE EFFECTIVELY GROUNDED.
- 4. MINIMUM SIZE OF WIRE SHALL BE 3.5 SQ. MM. THW IN 20 MM PVC CONDUIT OR 15 MM DIA. RSC UNLESS OTHERWISE SPECIFIED IN THE PLANS.
- 5. ELECTRICAL WORKS SHALL BE DONE UNDER THE DIRECT SUPERVISION OF A DULY LICENSED ELECTRICAL ENGINEER.
- 6. ALL MATERIALS TO BE USED IN THE INSTALLATION SHALL BE NEW, STANDARD AND APPROVED TYPE AS TO LOCATION, TYPE AND USE.
- METHOD OF WIRING SHALL BE RIGID STEEL CONDUIT (RSC) WITH PROPER FITTINGS, DEVICES, BOXES AND SUPPORTS WORK SHALL BE AS PER PLAN AND SPECIFICATIONS AS TO LOCATION, TYPE AND USE.
- 8. ALL SWITCHES AND CONVENIENCE OUTLETS (EXCEPT FLOOR MOUNTED) SHALL BE FLUSH MOUNTED, 1.40 METERS AND 0.30 METER, RESPECTIVELY, ABOVE FINISHED FLOOR.
- 9. CONDUIT RUNS ARE SCHEMATIC. ACTUAL RUNS SHALL BE DETERMINED IN THE FIELD TO SUIT ACTUAL FIELD CONDITION.
- 10. WIRES, BOXES, ELECTRICAL AS WELL AS NON-ELECTRICAL MATERIALS NOT INCLUDED IN THE PLANS AND SPECIFICATIONS BUT NECESSARY TO COMPLETE THE JOB SHALL BE FURNISHED AND INSTALLED BY THE CONTRACTOR.

TAPPED TO NEAREST EXISTING LINE


- 11. ALL DIMENSIONS SHOWN HERE IN ARE IN MILLIMETERS UNLESS OTHERWISE NOTED.
- 12. FOR SITE DEVELOPMENT PLAN, REFER TO DRAWING NO. A-2.

LEGEND

	LIGHTING CIRCUIT
0	7W ECO LED BULB ON CELING RECEPTACLE
Sa	TWO-GANG SWITCH WITH WEATHERPROOF PLATE COVER

NOTE:

 LOCATION OF EXISTING PANEL PP SHALL BE DETERMINED BY THE CONTRACTOR ON SITE TO SUIT ACTUAL FIELD CONDITION.

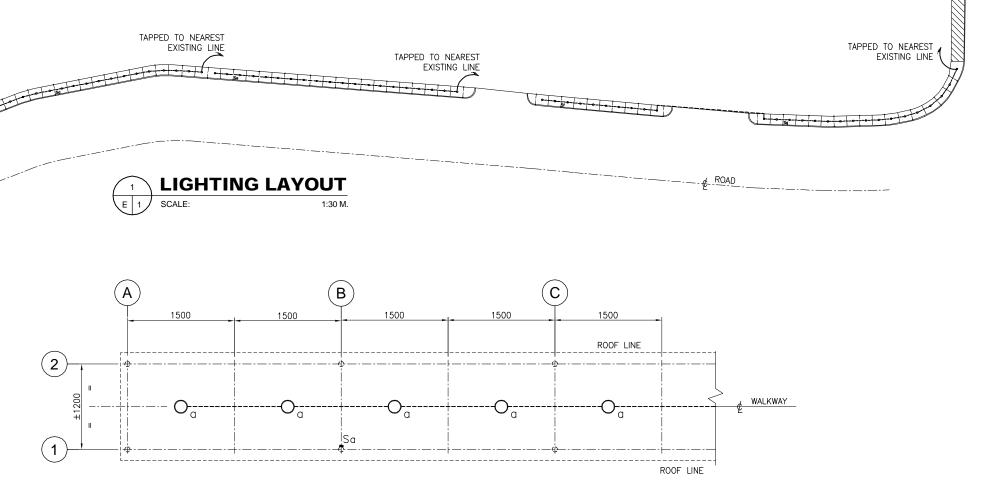



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93 Kalikasan Street Karangalan Village Phase 2A, Dela Paz, Pasig City 1611
Tel. No.: 682 7114 Fax. No.: 682 8467 Cellphone No.: 0920 9226441
URL: www.gibma.com E-mail: gibma2003@yahoo.com

	PROFESSION	BIONAL ELECTRICAL ENGINEER:			PROJECT TITLE :	OWNER:		REVISION:	DESCRIPTION:	DESIGNED BY:		SHEET CONTENTS:	DRAWING NO.:	
					DRODOSED COVERED WALKING DARKING	METAL INDUSTRY RESEARCH AND				CADD BY:	RHV	COVERED WALKWAY	F 1	
		AMADOR L. CRUZ			PROPOSED COVERED WALKWAY, PARKING AND DOST NORTH GATE SIGNAGE	DEVELOPMENT CENTER (MIRDC)			DATE:				E	
	REG. NO.: 0002267 PTR NO.: 6669191 DATE: 10 - 03 - 88 ISSUED ON: JAN. 3, 2017		6669191						CHECKED BY:	ALC / GBM	LIGHTING LAYOUT	SHEET NO.:		
			JAN. 3, 2017	LOCATION:	ADDRESS:				APPROVED BY:		NOTES & LEGEND	20 / 22		
	TIN:	138-735-734	ISSUED AT:	MARIKINA CITY	GEN. SANTOS AVE., BICUTAN, TAGUIG CITY, METRO MANILA	GEN. SANTOS AVE., BICUTAN, TAGUIG CITY, METRO MANILA				DATE:			20 / 22	

PARTIAL LIGHTING LAYOUT

GENERAL NOTES:


- 1. ALL ELECTRICAL WORKS SHALL BE DONE IN ACCORDANCE WITH THE PERTINENT PROVISIONS OF THE LATEST EDITION OF THE PHILIPPINE ELECTRICAL CODE.
- LOCATION OF LIGHTING FIXTURES ARE APPROXIMATE ONLY. FINAL PROVISIONS SHALL BE DETERMINED ON SITE TO AVOID INTERFERENCE WITH OTHER SYSTEM AND/OR EQUIPMENTS.
- 3. METALLIC FRAMES OF EQUIPMENTS SHALL BE EFFECTIVELY GROUNDED.
- 4. MINIMUM SIZE OF WIRE SHALL BE 3.5 SQ. MM. THW IN 20 MM PVC CONDUIT OR 15 MM DIA. RSC UNLESS OTHERWISE SPECIFIED IN THE PLANS.
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- 11. ALL DIMENSIONS SHOWN HERE IN ARE IN MILLIMETERS UNLESS OTHERWISE NOTED.
- 12. FOR SITE DEVELOPMENT PLAN, REFER TO DRAWING NO. A-2.

LEGEND

	LIGHTING CIRCUIT
0	18W HIGH POWER LED BULB ON CELING RECEPTACLE
Sa	ONE-GANG SWITCH WITH WEATHERPROOF PLATE COVER

NOTE:

 LOCATION OF EXISTING PANEL PP SHALL BE DETERMINED BY THE CONTRACTOR ON SITE TO SUIT ACTUAL FIELD CONDITION.

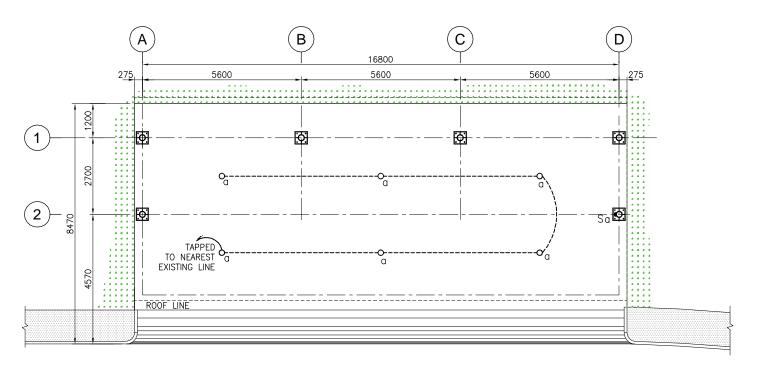



DRAWING NO

SHEET NO. :

E - 2

21 / 22



GIBMA Engineering Services

PROFESSION	NAL ELECTRICAL	ENGINEER:		PROJECT TITLE :	OWNER:	DATE:	REVISION:	DESCRIPTION:	DESIGNED BY:		SHEET CONTENTS:
				DDODOGED COVEDED WALKINAY DADKING	METAL INDUSTRY RESEARCH AND				CADD BY:	RHV	COVERED CAR PARKING LIGHTING LAYOUT
-	AMADOF	R L. CRUZ		PROPOSED COVERED WALKWAY, PARKING AND DOST NORTH GATE SIGNAGE	DEVELOPMENT CENTER (MIRDC)				DATE :		
REG. NO.:	REG. NO.: 0002267 PTR NO.: 6669191		6669191						CHECKED BY:	ALC / GBM	NOTES & LEGEND
DATE: 10 - 03 - 88 ISSUED ON: JAN. 3, 2017		JAN. 3, 2017	LOCATION:	ADDRESS:				APPROVED BY :			
TIN:	138-735-734	ISSUED AT:	MARIKINA CITY	GEN. SANTOS AVE., BICUTAN, TAGUIG CITY, METRO MANILA	GEN. SANTOS AVE., BICUTAN, TAGUIG CITY, METRO MANILA				DATE:		

GENERAL NOTES:


- 1. ALL ELECTRICAL WORKS SHALL BE DONE IN ACCORDANCE WITH THE PERTINENT PROVISIONS OF THE LATEST EDITION OF THE PHILIPPINE ELECTRICAL CODE.
- 2. LOCATION OF LIGHTING FIXTURES ARE APRROXIMATE ONLY. FINAL PROVISIONS SHALL BE DETERMINED ON SITE TO AVOID INTERFERENCE WITH OTHER SYSTEM
- 3. METALLIC FRAMES OF EQUIPMENTS SHALL BE EFFECTIVELY GROUNDED.
- 4. MINIMUM SIZE OF WIRE SHALL BE 3.5 SQ. MM. THW IN 20 MM PVC CONDUIT OR 15 MM DIA. RSC UNLESS OTHERWISE SPECIFIED IN THE PLANS.
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- 9. CONDUIT RUNS ARE SCHEMATIC. ACTUAL RUNS SHALL BE DETERMINED IN THE FIELD TO SUIT ACTUAL FIELD CONDITION.
- 10. WIRES, BOXES, ELECTRICAL AS WELL AS NON-ELECTRICAL MATERIALS NOT INCLUDED IN THE PLANS AND SPECIFICATIONS BUT NECESSARY TO COMPLETE THE JOB SHALL BE FURNISHED AND INSTALLED BY THE CONTRACTOR.
- 11. ALL DIMENSIONS SHOWN HERE IN ARE IN MILLIMETERS UNLESS OTHERWISE NOTED.
- 12. FOR SITE DEVELOPMENT PLAN, REFER TO DRAWING NO. A-2.

LEGEND

	LIGHTING CIRCUIT					
0	18W HIGH POWER LED BULB ON CELING RECEPTACLE					
Sa	ONE-GANG SWITCH WITH WEATHERPROOF PLATE COVER					

NOTE:

1. LOCATION OF EXISTING PANEL PP SHALL BE DETERMINED BY THE CONTRACTOR ON SITE TO SUIT ACTUAL FIELD CONDITION.

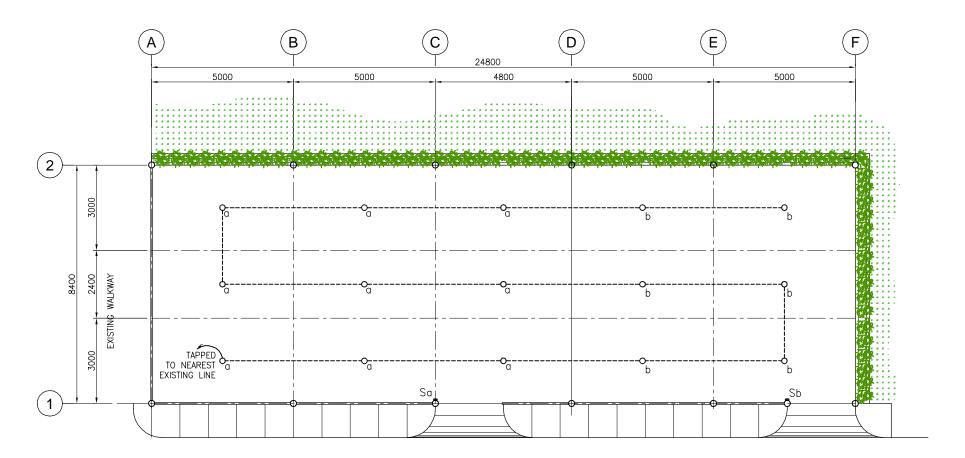



DRAWING NO

SHEET NO. :

E - 3

22 / 22



GIBMA Engineering Services

PROFESSION	NAL ELECTRICAL	ENGINEER:		PROJECT TITLE :	OWNER:	DATE :	REVISION:	DESCRIPTION:	DESIGNED BY:		SHEET CONTENTS:	
				PROPOSED COVERED WALKWAY, PARKING AND DOST NORTH GATE SIGNAGE	METAL INDUSTRY RESEARCH AND DEVELOPMENT CENTER (MIRDC)				CADD BY:	RHV	COVERED MOTORCYCLE PARKING	
_	AMADOF	R L. CRUZ							DATE:		LICUTING LAYOUT	
REG. NO.:	REG. NO.: 0002267 PTR NO.: 6669191		6669191						CHECKED BY:	ALC / GBM	LIGHTING LAYOUT NOTES & LEGEND	
DATE: 10 - 03 - 88 ISSUED ON: JAN. 3, 2017		JAN. 3, 2017	LOCATION:	ADDRESS:				APPROVED BY:				
TIN:	138-735-734	ISSUED AT:	MARIKINA CITY	GEN. SANTOS AVE., BICUTAN, TAGUIG CITY, METRO MANILA	GEN. SANTOS AVE., BICUTAN, TAGUIG CITY, METRO MANILA				DATE:			